



LOCUS CONTEXT MAP:

GRAPHIC SCALE

SCALE: 1"=200'

FEET

200

0 100 200

400

800

METERS

0 50 100

200

300

LSDP 15, LLC SOLAR DEVELOPMENT 280 & 0 OLD FALMOUTH ROAD (ASSESSOR'S MAP 100 - LOTS 7 & 8) -(TO ACCOMPANY A DEVELOPMENT OF REGIONAL IMPACT APPLICATION-

PLANS AND DESIGN HAVE BEEN DEVELOPED IN ACCORDANCE WITH
THE TOWN OF BARNSTABLE ZONING REGULATIONS
ARTICLE III: DISTRICT REGULATIONS, ARTICLE V: ACCESSORY USES,
ARTICLE IX: SITE PLAN REVIEW, & CAPE COD COMMISSION
DEVELOPMENT OF REGIONAL IMPACT APPLICATION SECTION II-4

LOCATED IN



BARNSTABLE, MASSACHUSETTS

DATE: AUGUST 15, 2016

APPLICANT:

LSDP 15, LLC

C/O LAKE STREET DEVELOPMENT PARTNERS

180 NORTH STETSON AVENUE

SUITE 3500

CHICAGO, IL 60601

TEL: 847-804-3051

LAND SURVEYOR/SITE CIVIL ENGINEER:



500 CUMMINGS CENTER SUITE 5950
BEVERLY, MASSACHUSETTS 01915
TELEPHONE: (978) 299-0447
WWW.MERIDIANASSOC.COM

69 MILK STREET, SUITE 302
WESTBOROUGH, MASSACHUSETTS 01581
TELEPHONE: (508) 871-7030

RECORD OWNERS:

EAC ORGANICS INC 9289 BONTA BRIDGE ROAD JORDAN, NEW YORK 13080 TEL: 315-689-1937

ENVIRONMENTAL CONSULTANT:



LEC ENVIRONMENTAL CONSULTANTS, INC.

12 RESNIK ROAD, SUITE 1

PLYMOUTH, MA 02360


TEL: (508) 746-9491 FAX: (508) 746-9492


WWW.LECENVIRONMENTAL.COM


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DEED DESCRIPTION: O OLD FALMOUTH ROAD

THE LAND IN BARNSTABLE (MARSTON MILLS) IN THE TOWN AND COUNTY OF BARNSTABLE, BOUNDED AND DESCRIBED AS FOLLOWS:

BY OLD FALMOUTH ROAD, A PUBLIC WAY, ABOUT SEVEN HUNDRED SOUTHERLY SEVENTY-FOUR (774+/-) FEET;

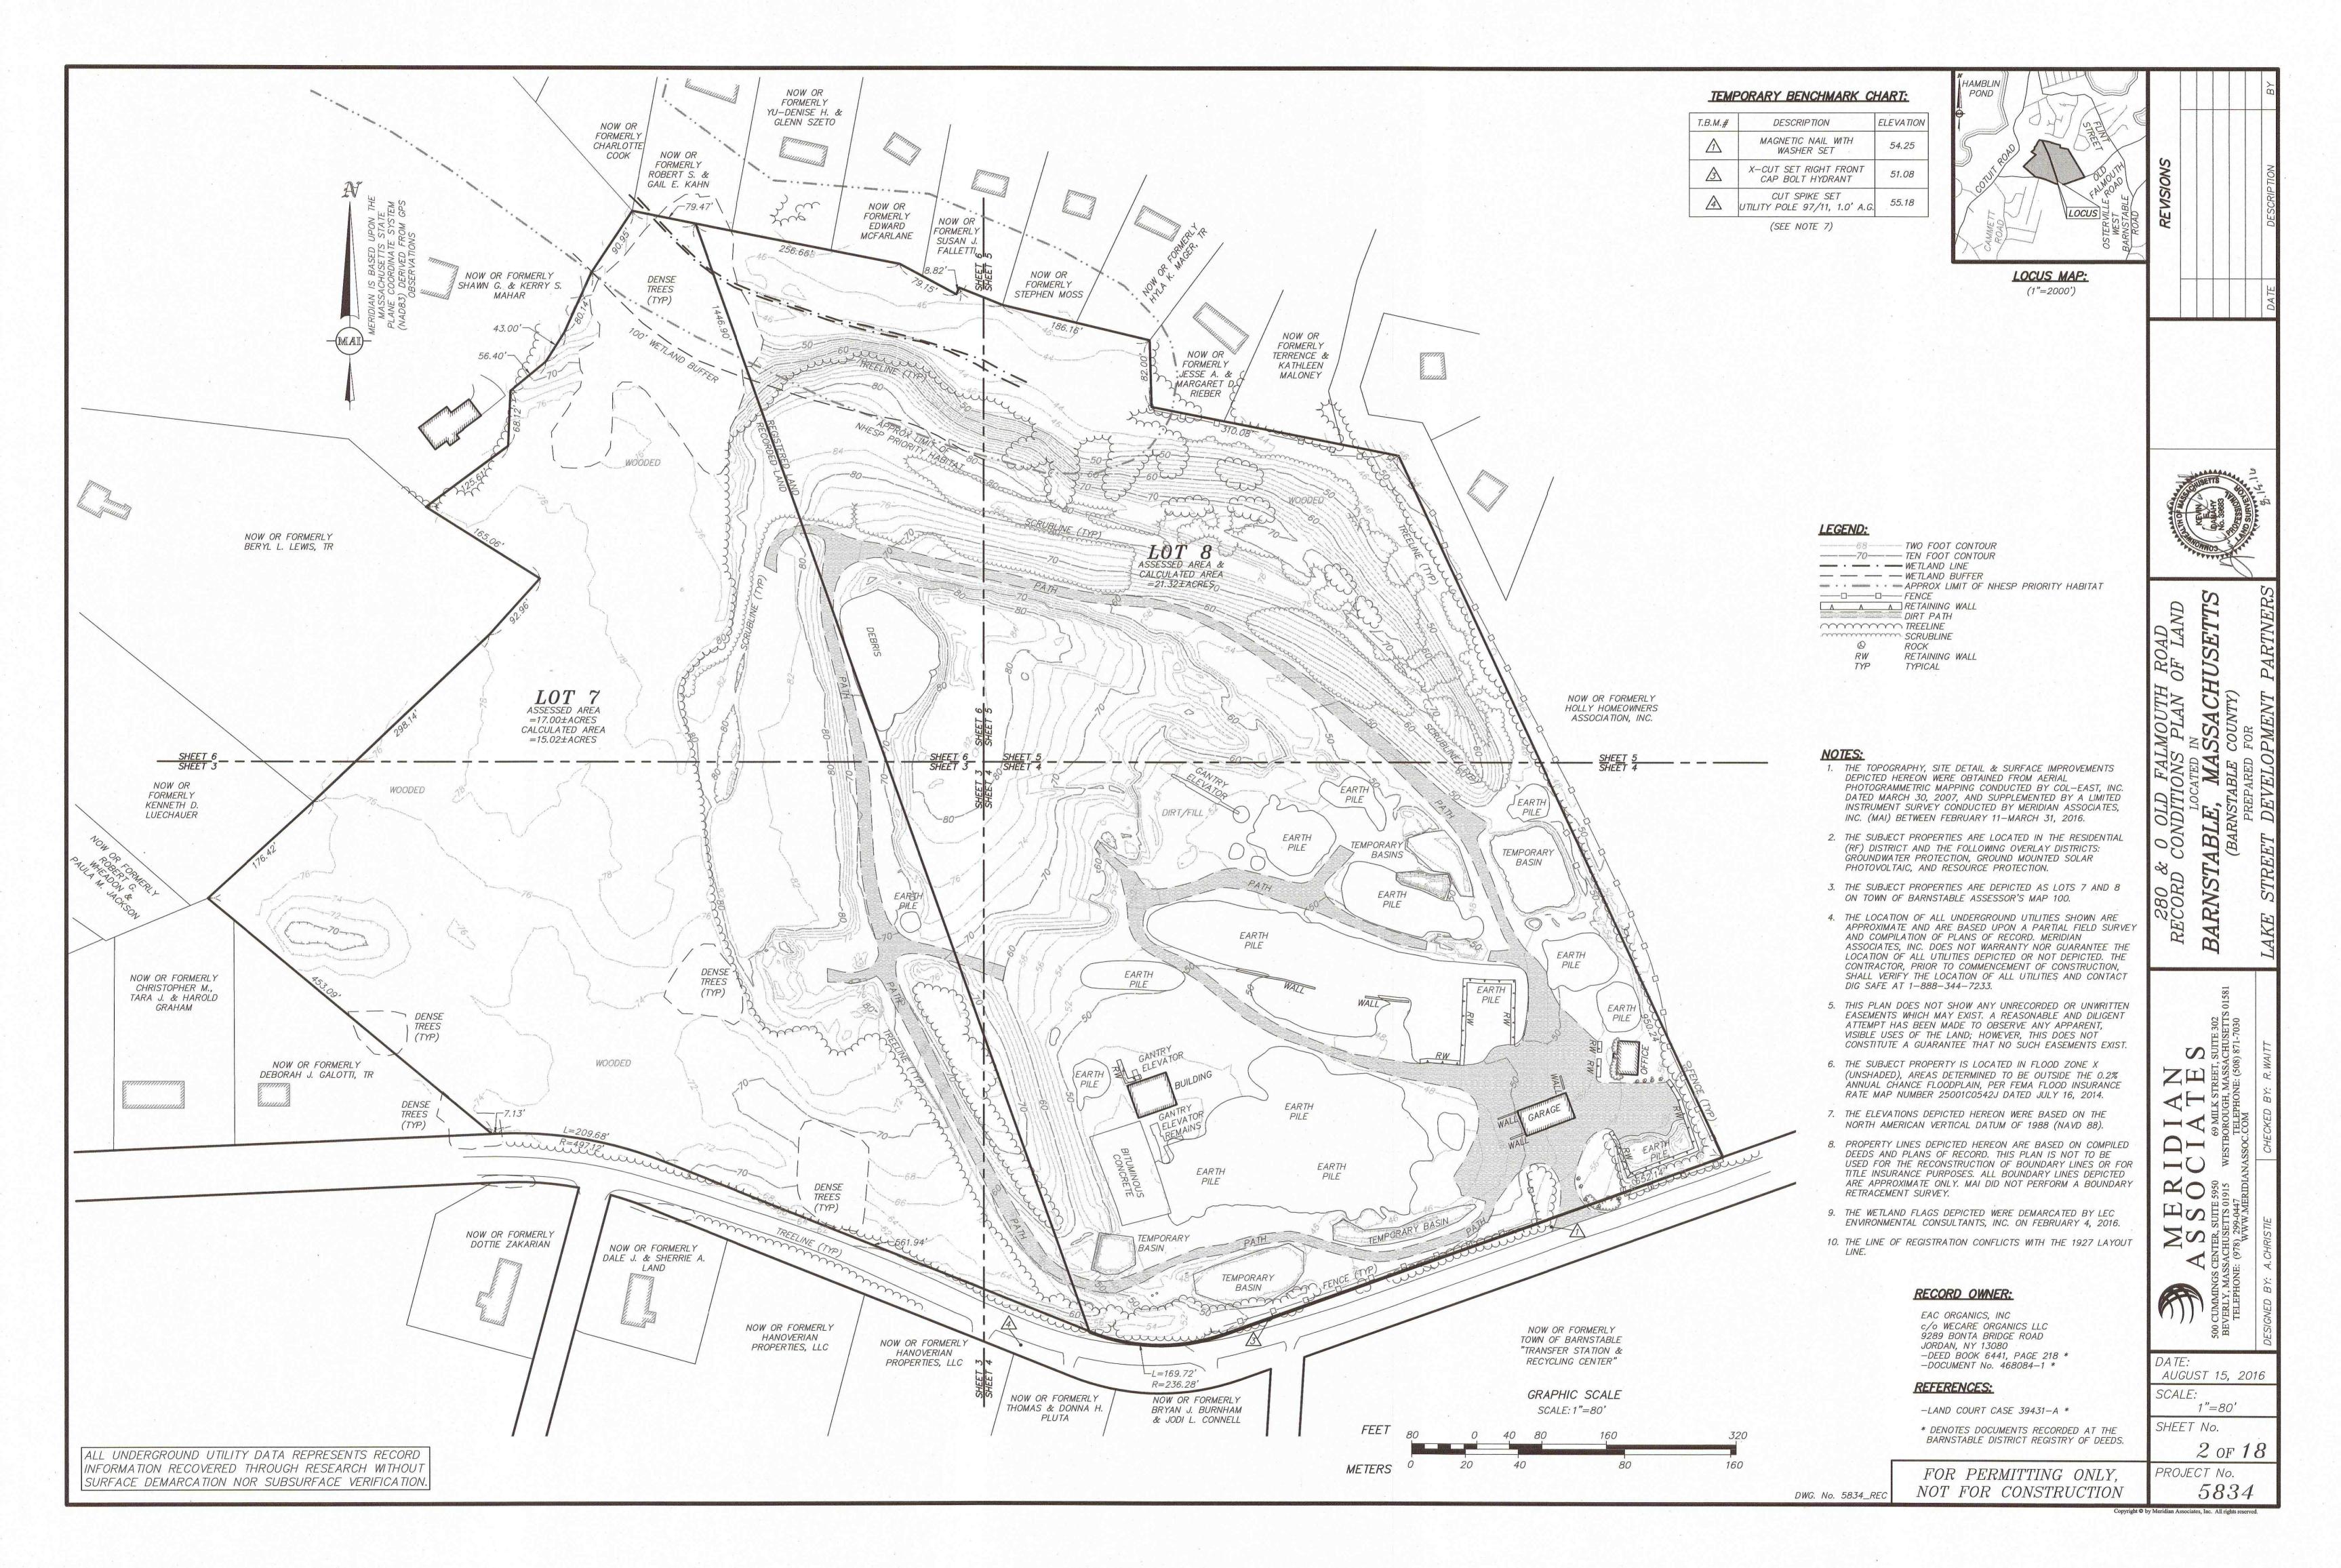SOUTHWESTERLY BY LAND NOW OR FORMERLY OF MARY M. MACLEOD, FIVE HUNDRED

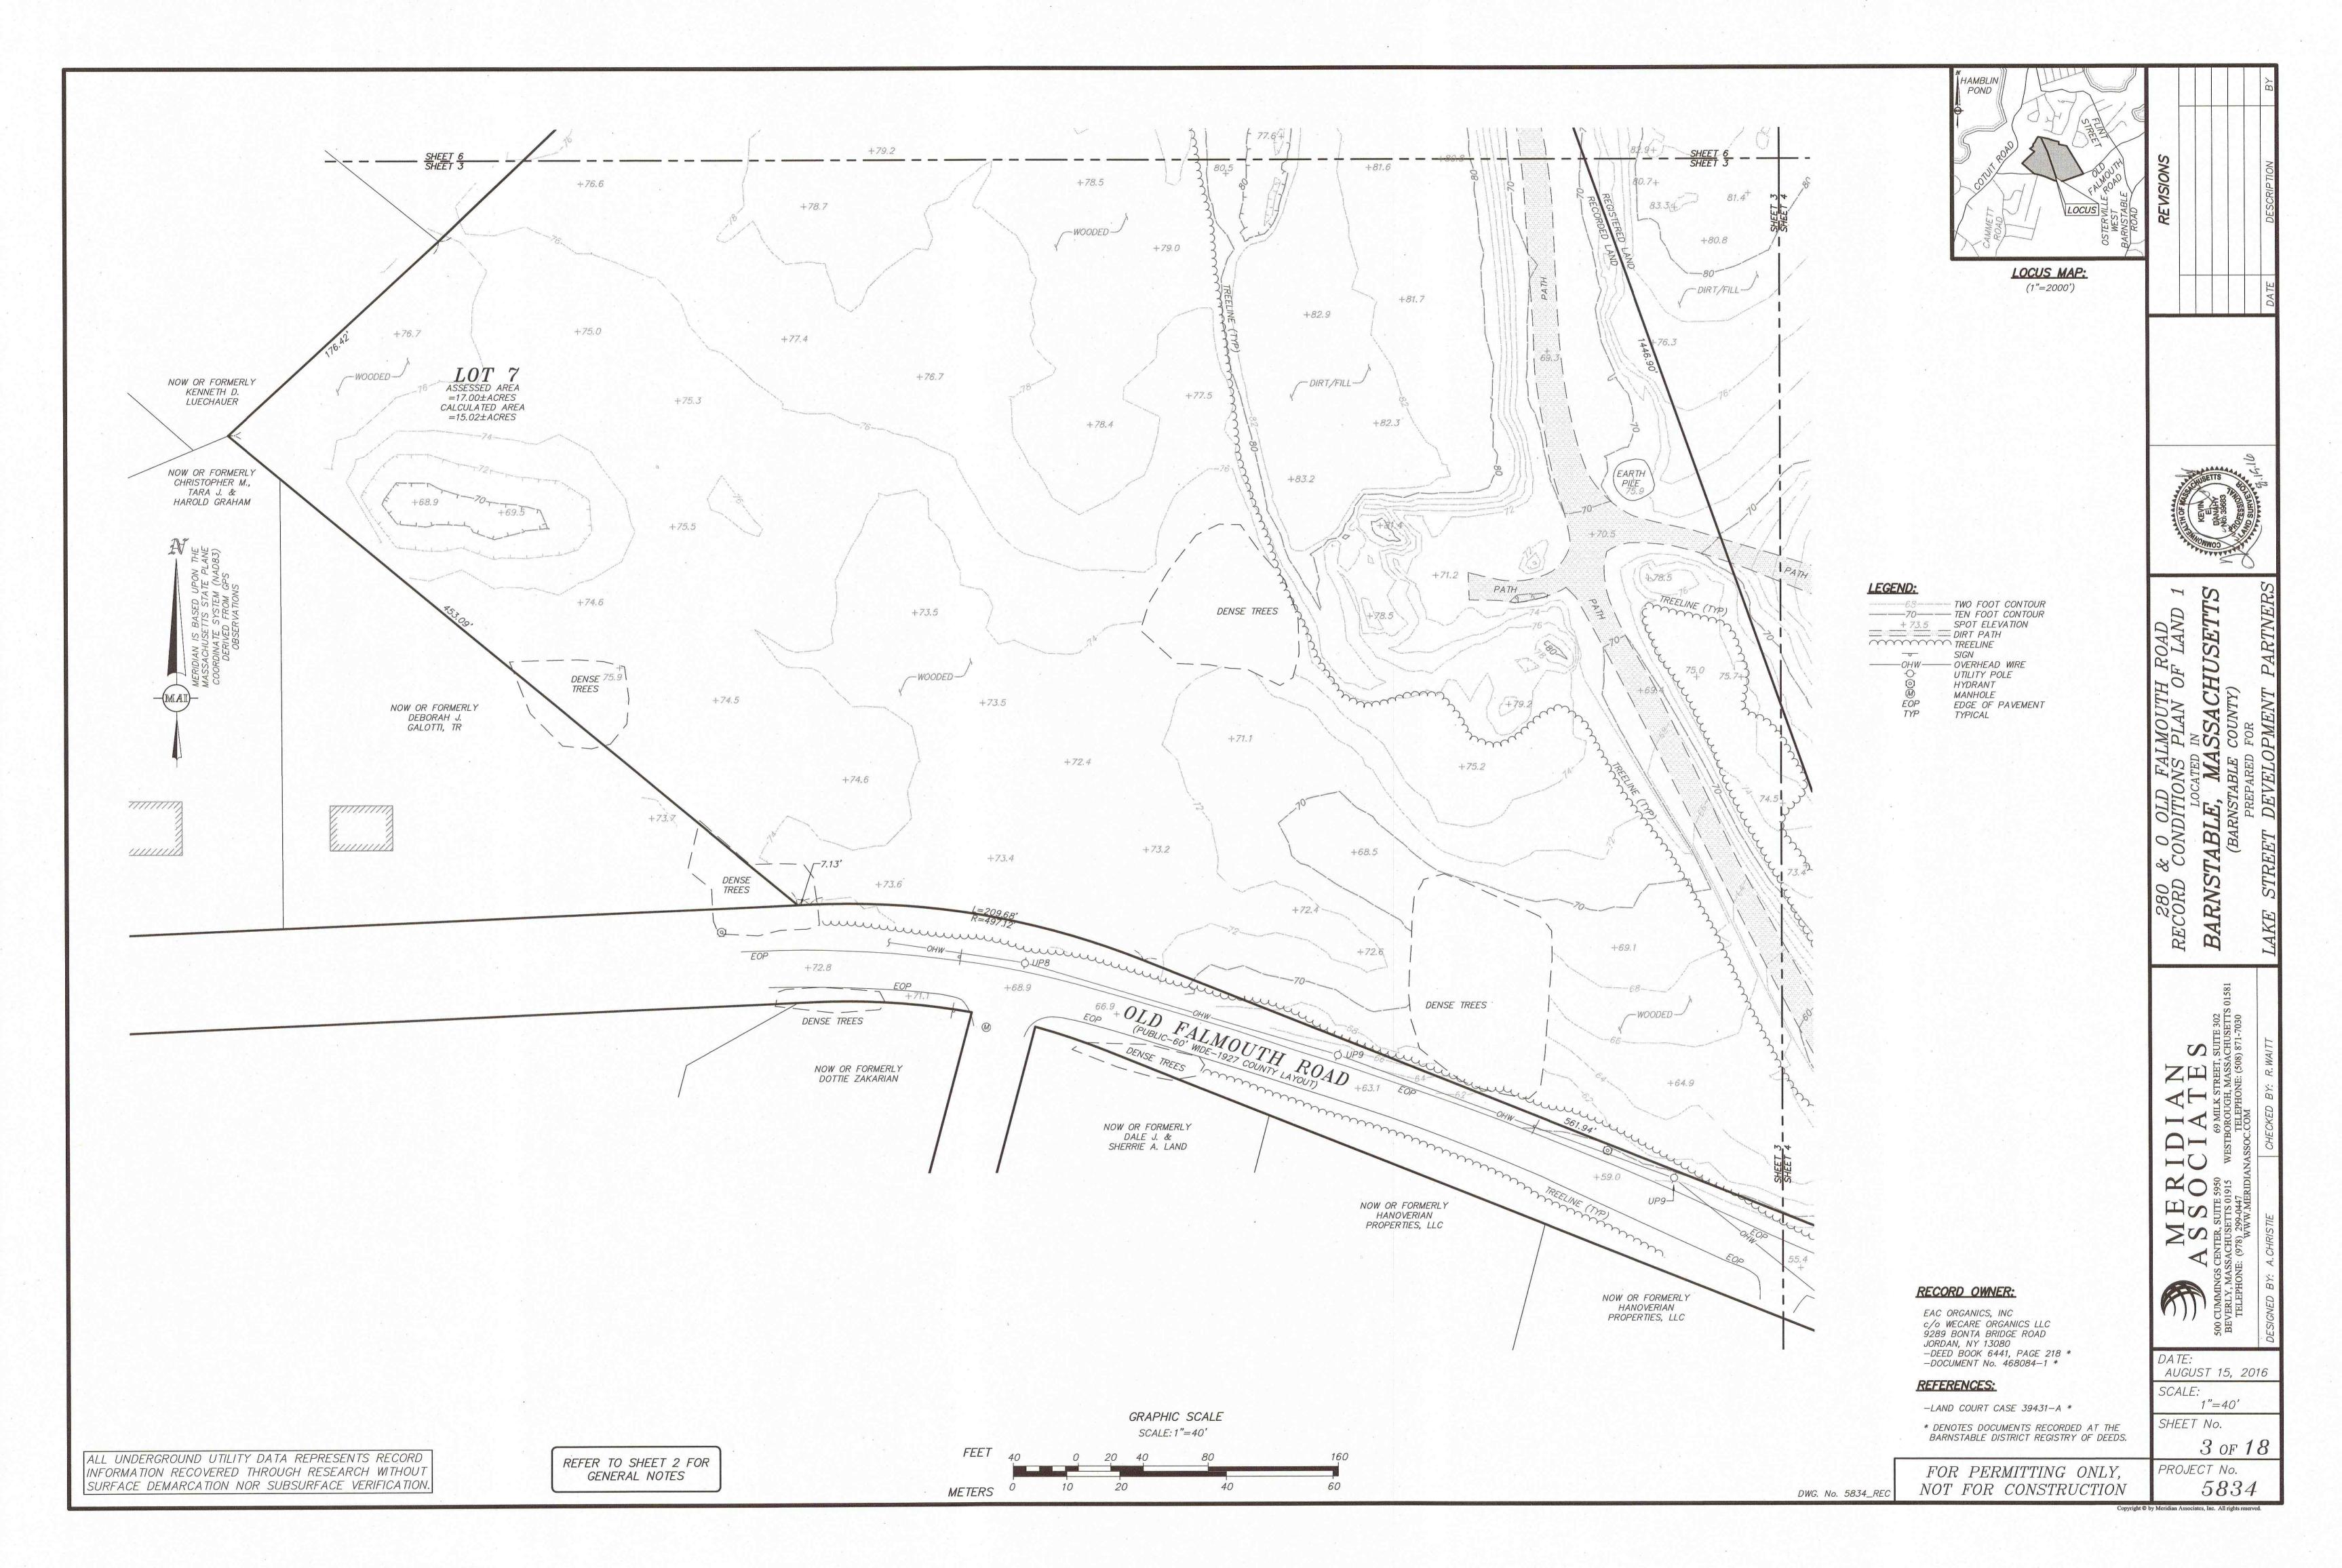TWENTY-FIVE (525) FEET;

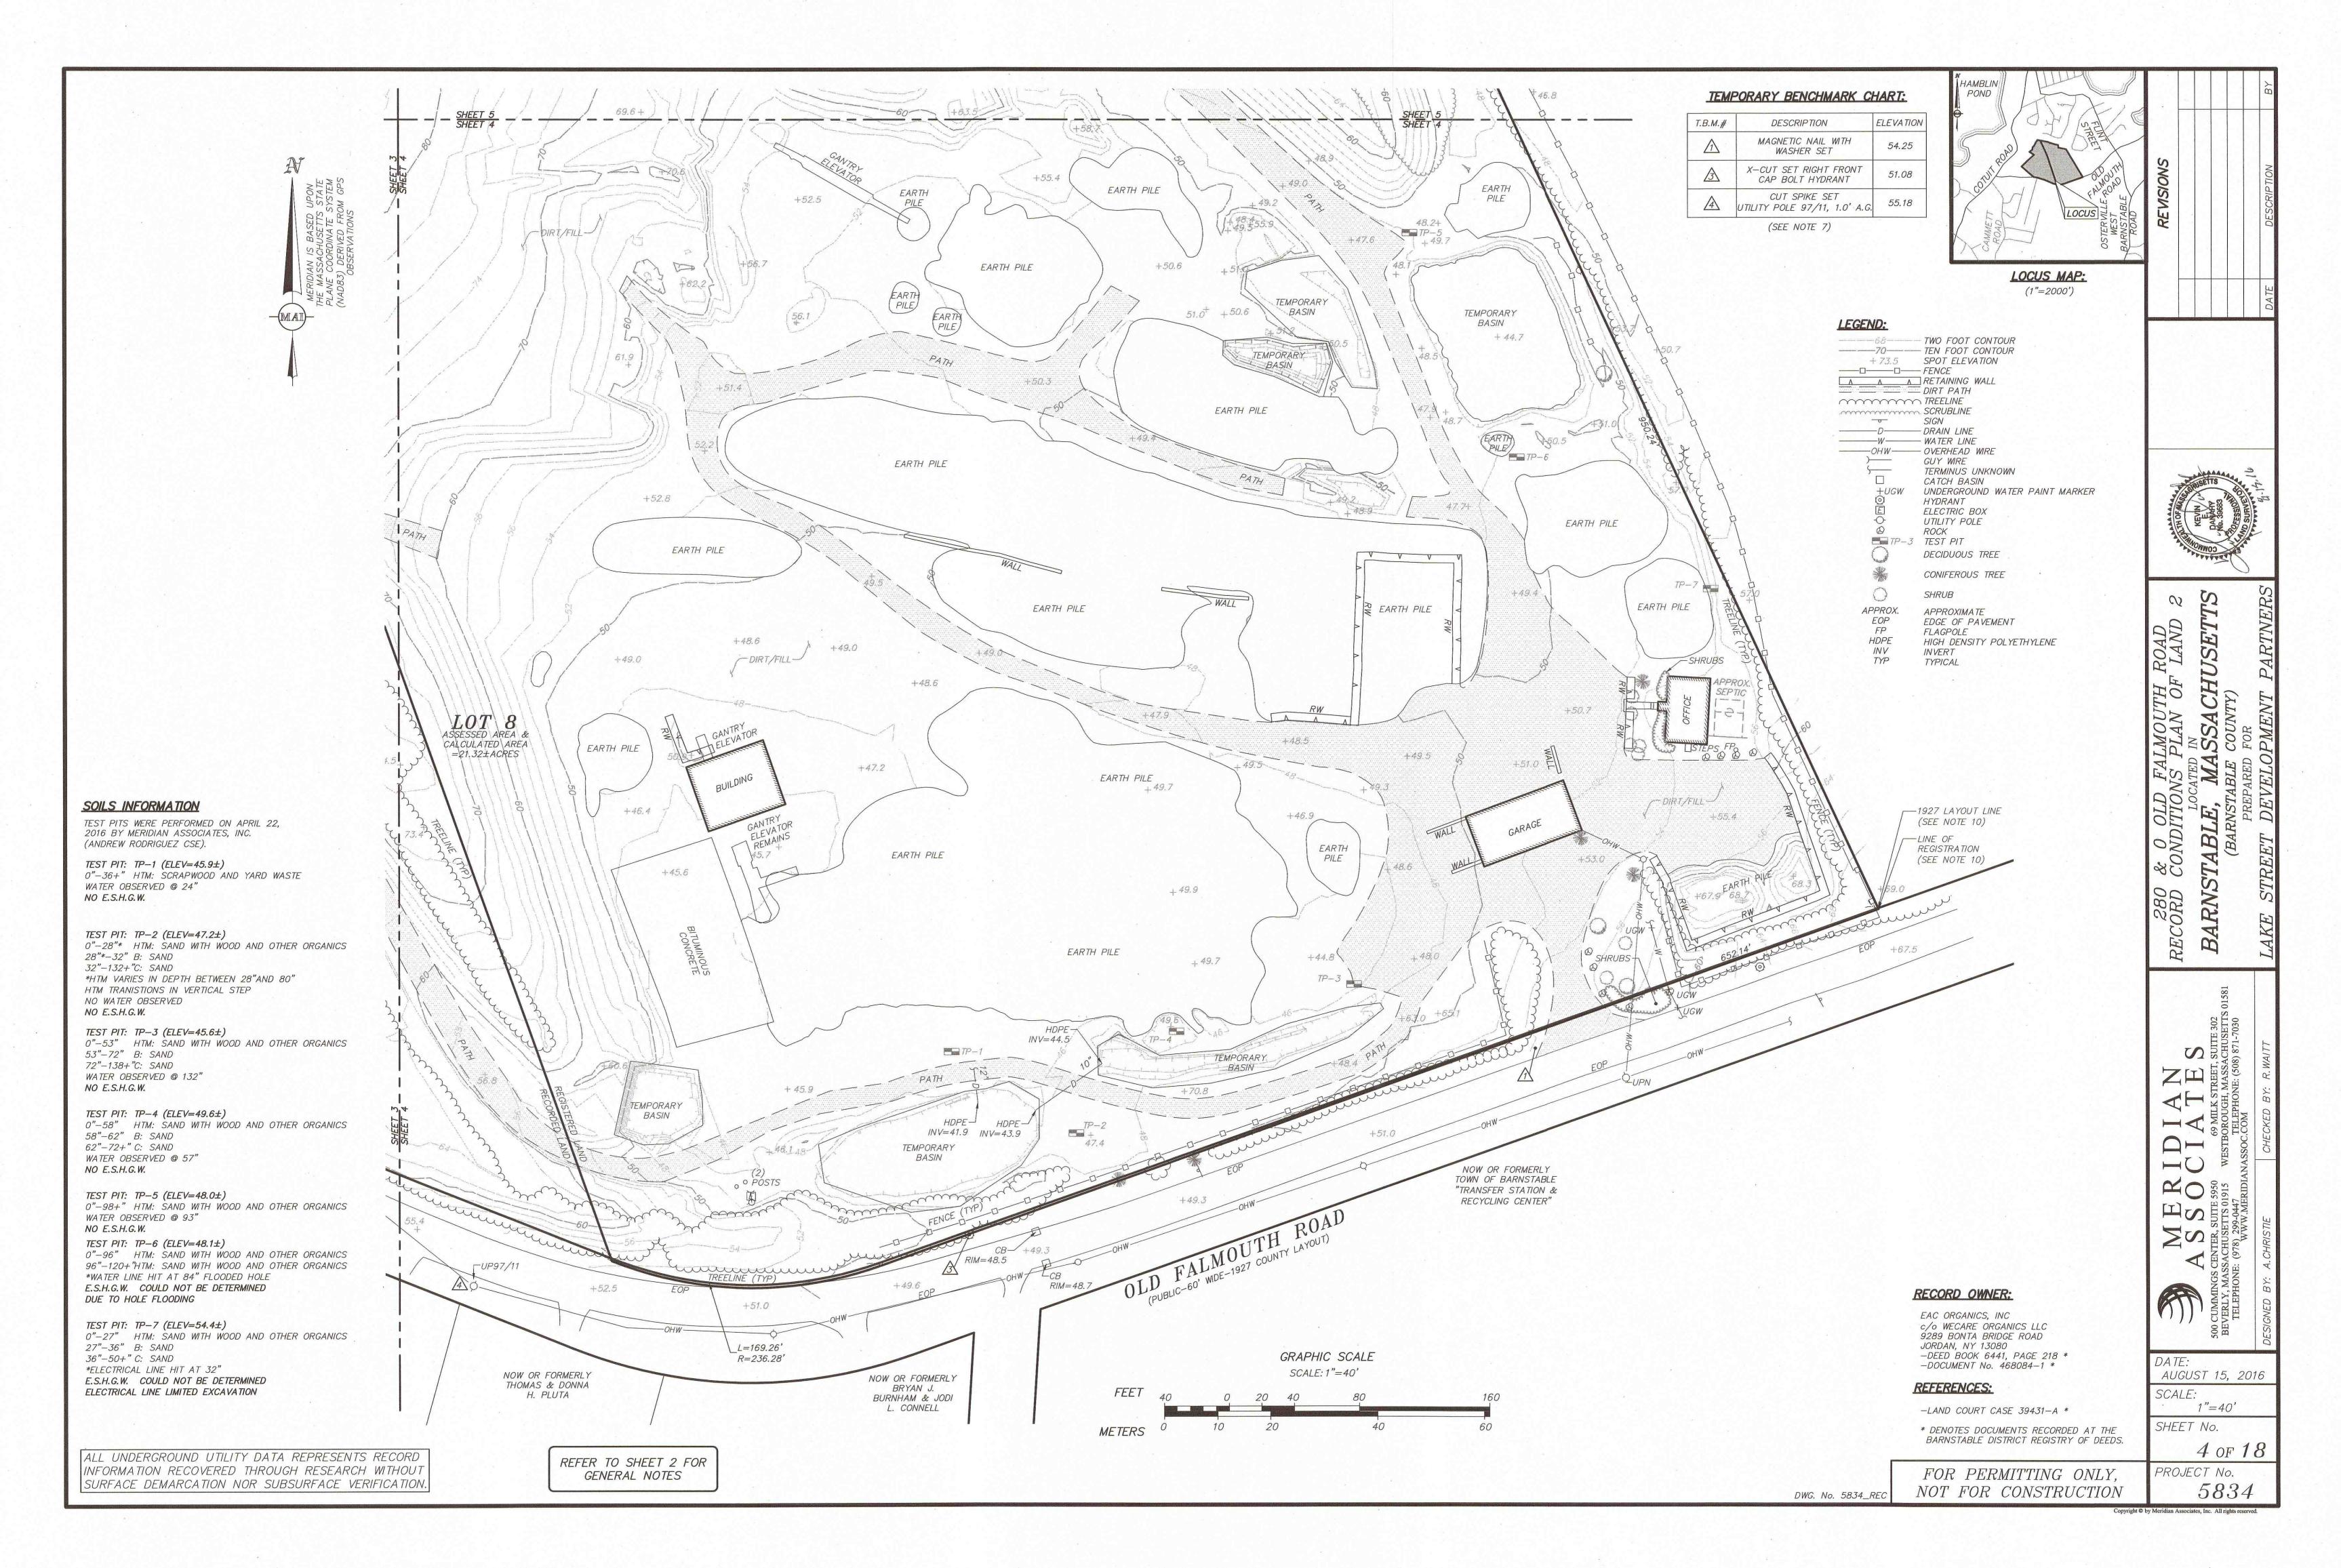SEVENTY-FIVE (575) FEET;

NORTHWESTERLY

NORTHWESTERLY STILL IN THE SAME LINE BY LAND NOW OR FORMERLY OF WOLCOTT E. CHESLEY, ONE HUNDRED FORTY-SEVEN AND 64/100 (147.64) FEET:

BY SAID LAND NOW OR FORMERLY OF MACLEOD, FIVE HUNDRED

(SEE PLAN IN PLAN BOOK 164, PAGE 93)

BY SAID LAND NOW OR FORMERLY OF CHESLEY, SIXTY-EIGHT AND SOUTHWESTERLY

10/100 (68.10) FEET;

NORTHWESTERLY AND BY THE CENTERLINE OF AN OLD ROAD AND BY SAID LAND OF CHESLEY, ABOUT TWO HUNDRED EIGHTY (280+/-) FEET TO A

NORTHEASTERLY BY LAND NOW OR FORMERLY OF CORNELIUS J. AND ARLENE M. FAIR BY TWO COURSES MEASURING THREE HUNDRED THIRTY-SIX AND 07/100 (336.07) FEET AND SEVENTY-NINE AND 26/100 (79.26)

FEET RESPECTIVELY; (SEE PLAN IN PLAN BOOK 233, PAGE 121) EASTERLY BY LAND OF CAPE RESOURCES, INC., BEING LAND COURT CASE NO.

39431A, ONE THOUSAND FOUR HUNDRED FORTY-SIX AND 90/100 (1446.90) FEET.

CONTAINING 17 ACRES MORE OR LESS AND BEING SHOWN AS PARCEL 7 ON BARNSTABLE ASSESSORS MAP 100 (FISCAL YEAR 1986).

FOR TITLE SEE DEED OF RICHARD B. SELLARS DATED MARCH 12, 1987, AND RECORDED IN BARNSTABLE DEEDS BOOK 5605, PAGE 42.

DEED DESCRIPTION: 280 OLD FALMOUTH ROAD

THE LAND IN BARNSTABLE (MARSTON MILLS) IN THE TOWN AND COUNTY OF BARNSTABLE, BOUNDED AND DESCRIBED AS FOLLOWS:

SOUTHERLY AND BY BARNSTABLE-FALMOUTH ROAD, EIGHT HUNDRED TWENTY-ONE SOUTHWESTERLY AND 86/100 (821.86) FEET;

BY LAND NOW OR FORMERLY OF ADDIE F. WEBSTER ET. AL., WESTERLY FOURTEEN HUNDRED FORTY-SIX AND 90/100 (1446.90) FEET;

BY LAND NOW OR FORMERLY OF CHARLES E. LARSON ET. AL, NORTHEASTERLY THREE HUNDRED THIRTY-FIVE AND 81/100 (335.81) FEET;

NORTHWESTERLY BY EIGHT AND 62/100 (8.62) FEET:

NORTHEASTERLY BY TWO HUNDRED FORTY-THREE AND 81/100 (243.81) FEET, BY

SAID LAND NOW OR FORMERLY OF CHARLES E. LARSON ET. AL.:

EASTERLY EIGHTY-TWO (82) FEET; AND


NORTHEASTERLY THREE HUNDRED TEN AND 08/100 (310.08) FEET, BY SAID LAND NOW OR FORMERLY OF CHARLES E. LARSON ET. AL.,: AND

EASTERLY BY LAND OF OWNER UNKNOWN, NINE HUNDRED FIFTY AND 24/100

(950.24) FEET.

ALL OF SAID BOUNDARIES ARE DETERMINED BY THE COURT TO BE LOCATED AS SHOWN ON PLAN 39431-A DATED OCTOBER 24, 1974, DRAWN BY BAXTER & NYE, INC., SURVEYORS, AND FILED IN THE LAND REGISTRATION OFFICE AT BOSTON, A COPY OF WHICH IS FILED IN BARNSTABLE COUNTY REGISTRY OF DEEDS IN LAND REGISTRATION BOOK 690, PAGE 14, WITH CERTIFICATE OF TITLE NO. 84874.

FOR TITLE, SEE CERTIFICATE OF TITLE NO. 106718.

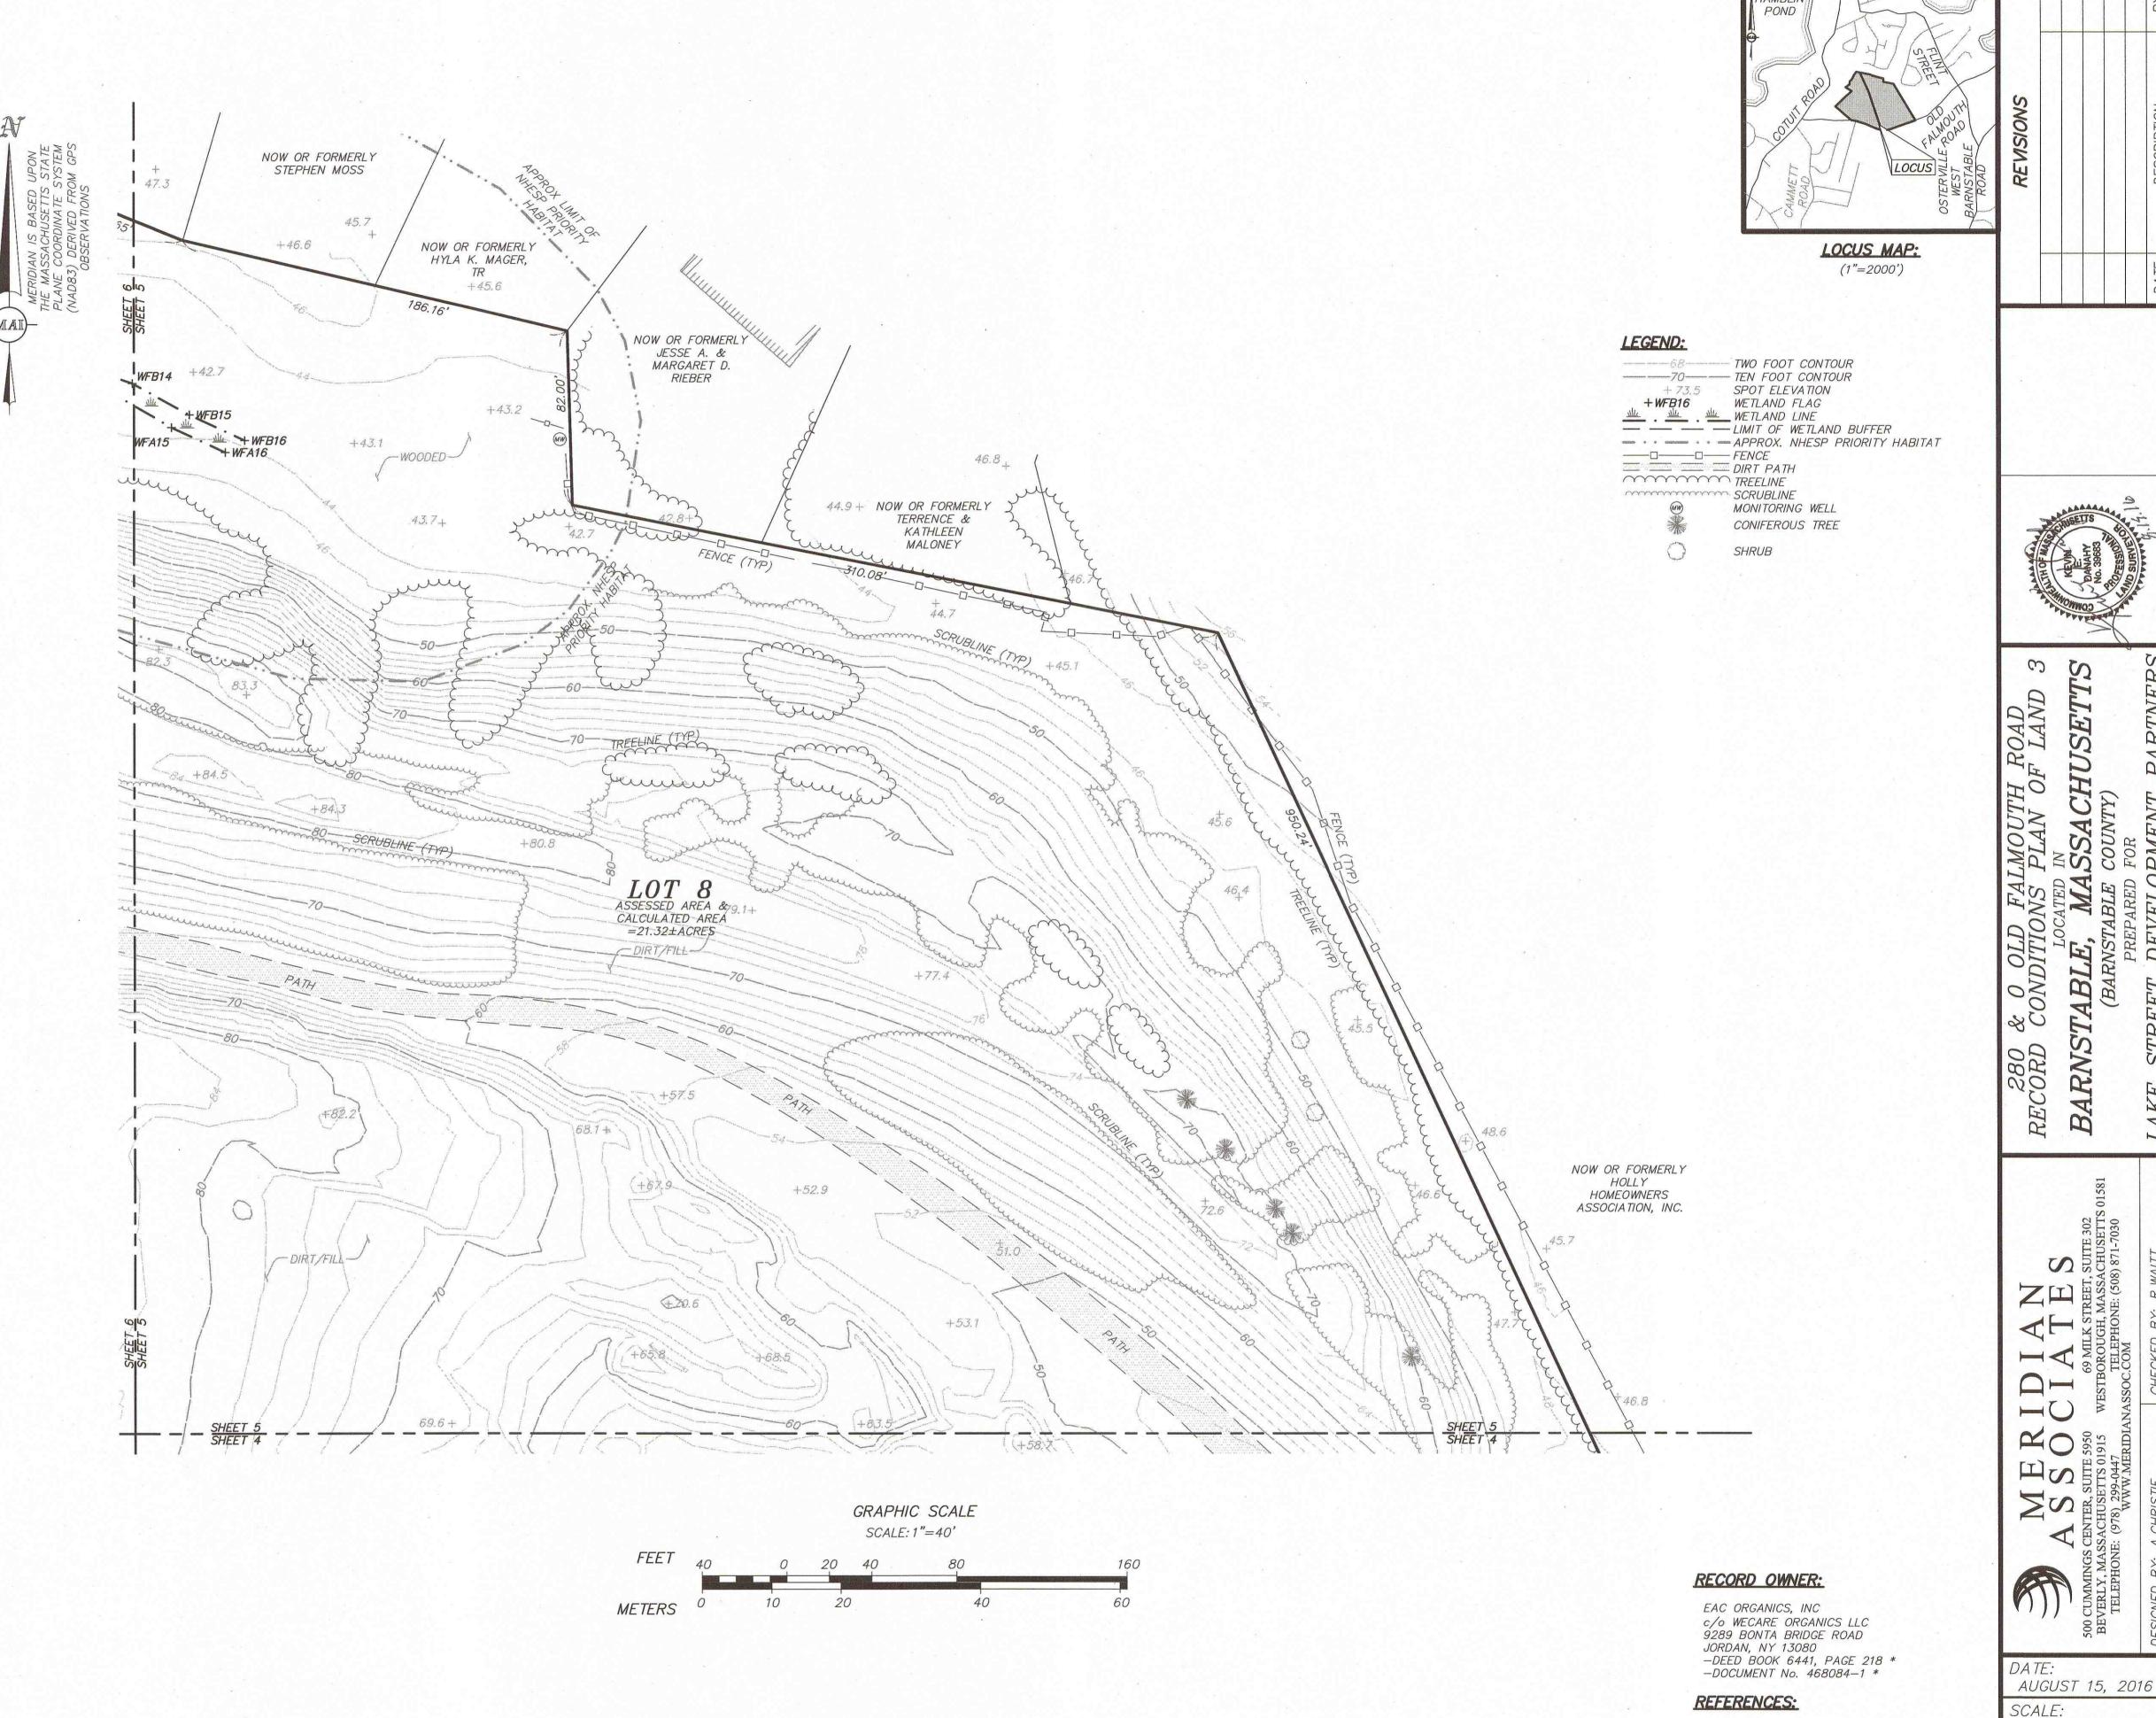

ALL UNDERGROUND UTILITY DATA REPRESENTS RECORD INFORMATION RECOVERED THROUGH RESEARCH WITHOUT SURFACE DEMARCATION NOR SUBSURFACE VERIFICATION.

REFER TO SHEET 2 FOR GENERAL NOTES

DWG. No. 5834_REC

FOR PERMITTING ONLY, NOT FOR CONSTRUCTION

* DENOTES DOCUMENTS RECORDED AT THE BARNSTABLE DISTRICT REGISTRY OF DEEDS.

-LAND COURT CASE 39431-A *

PROJECT No.


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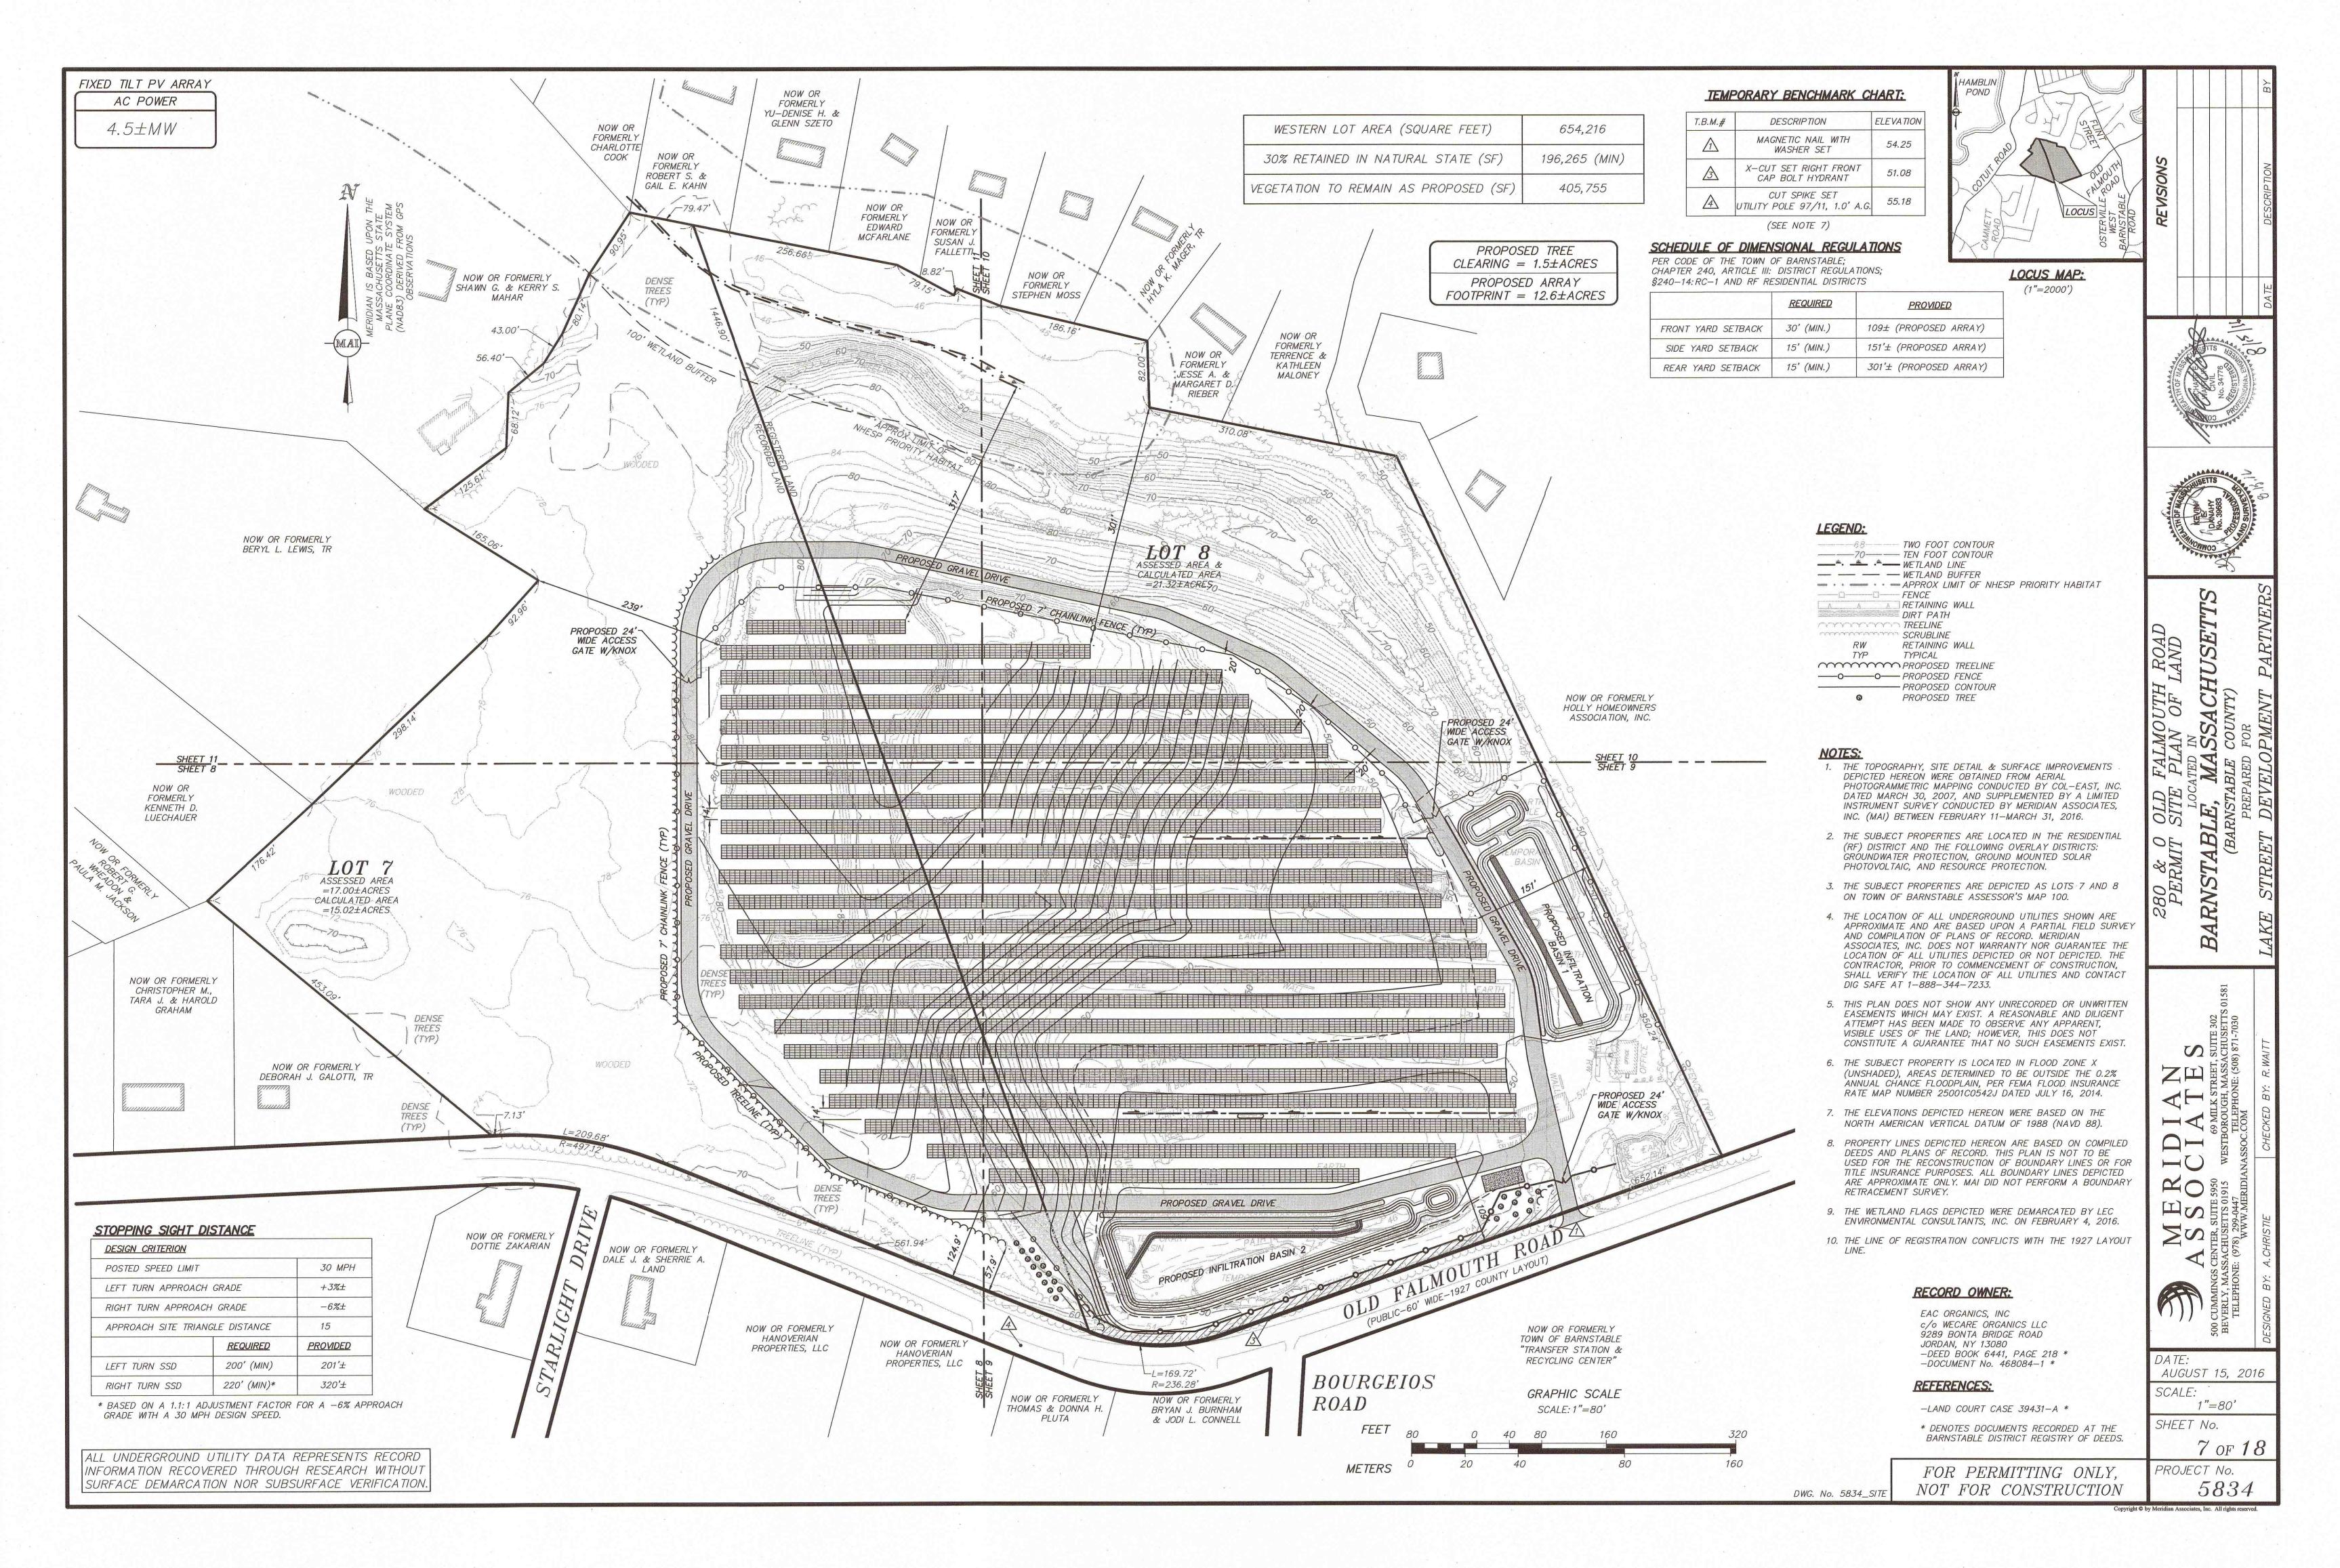
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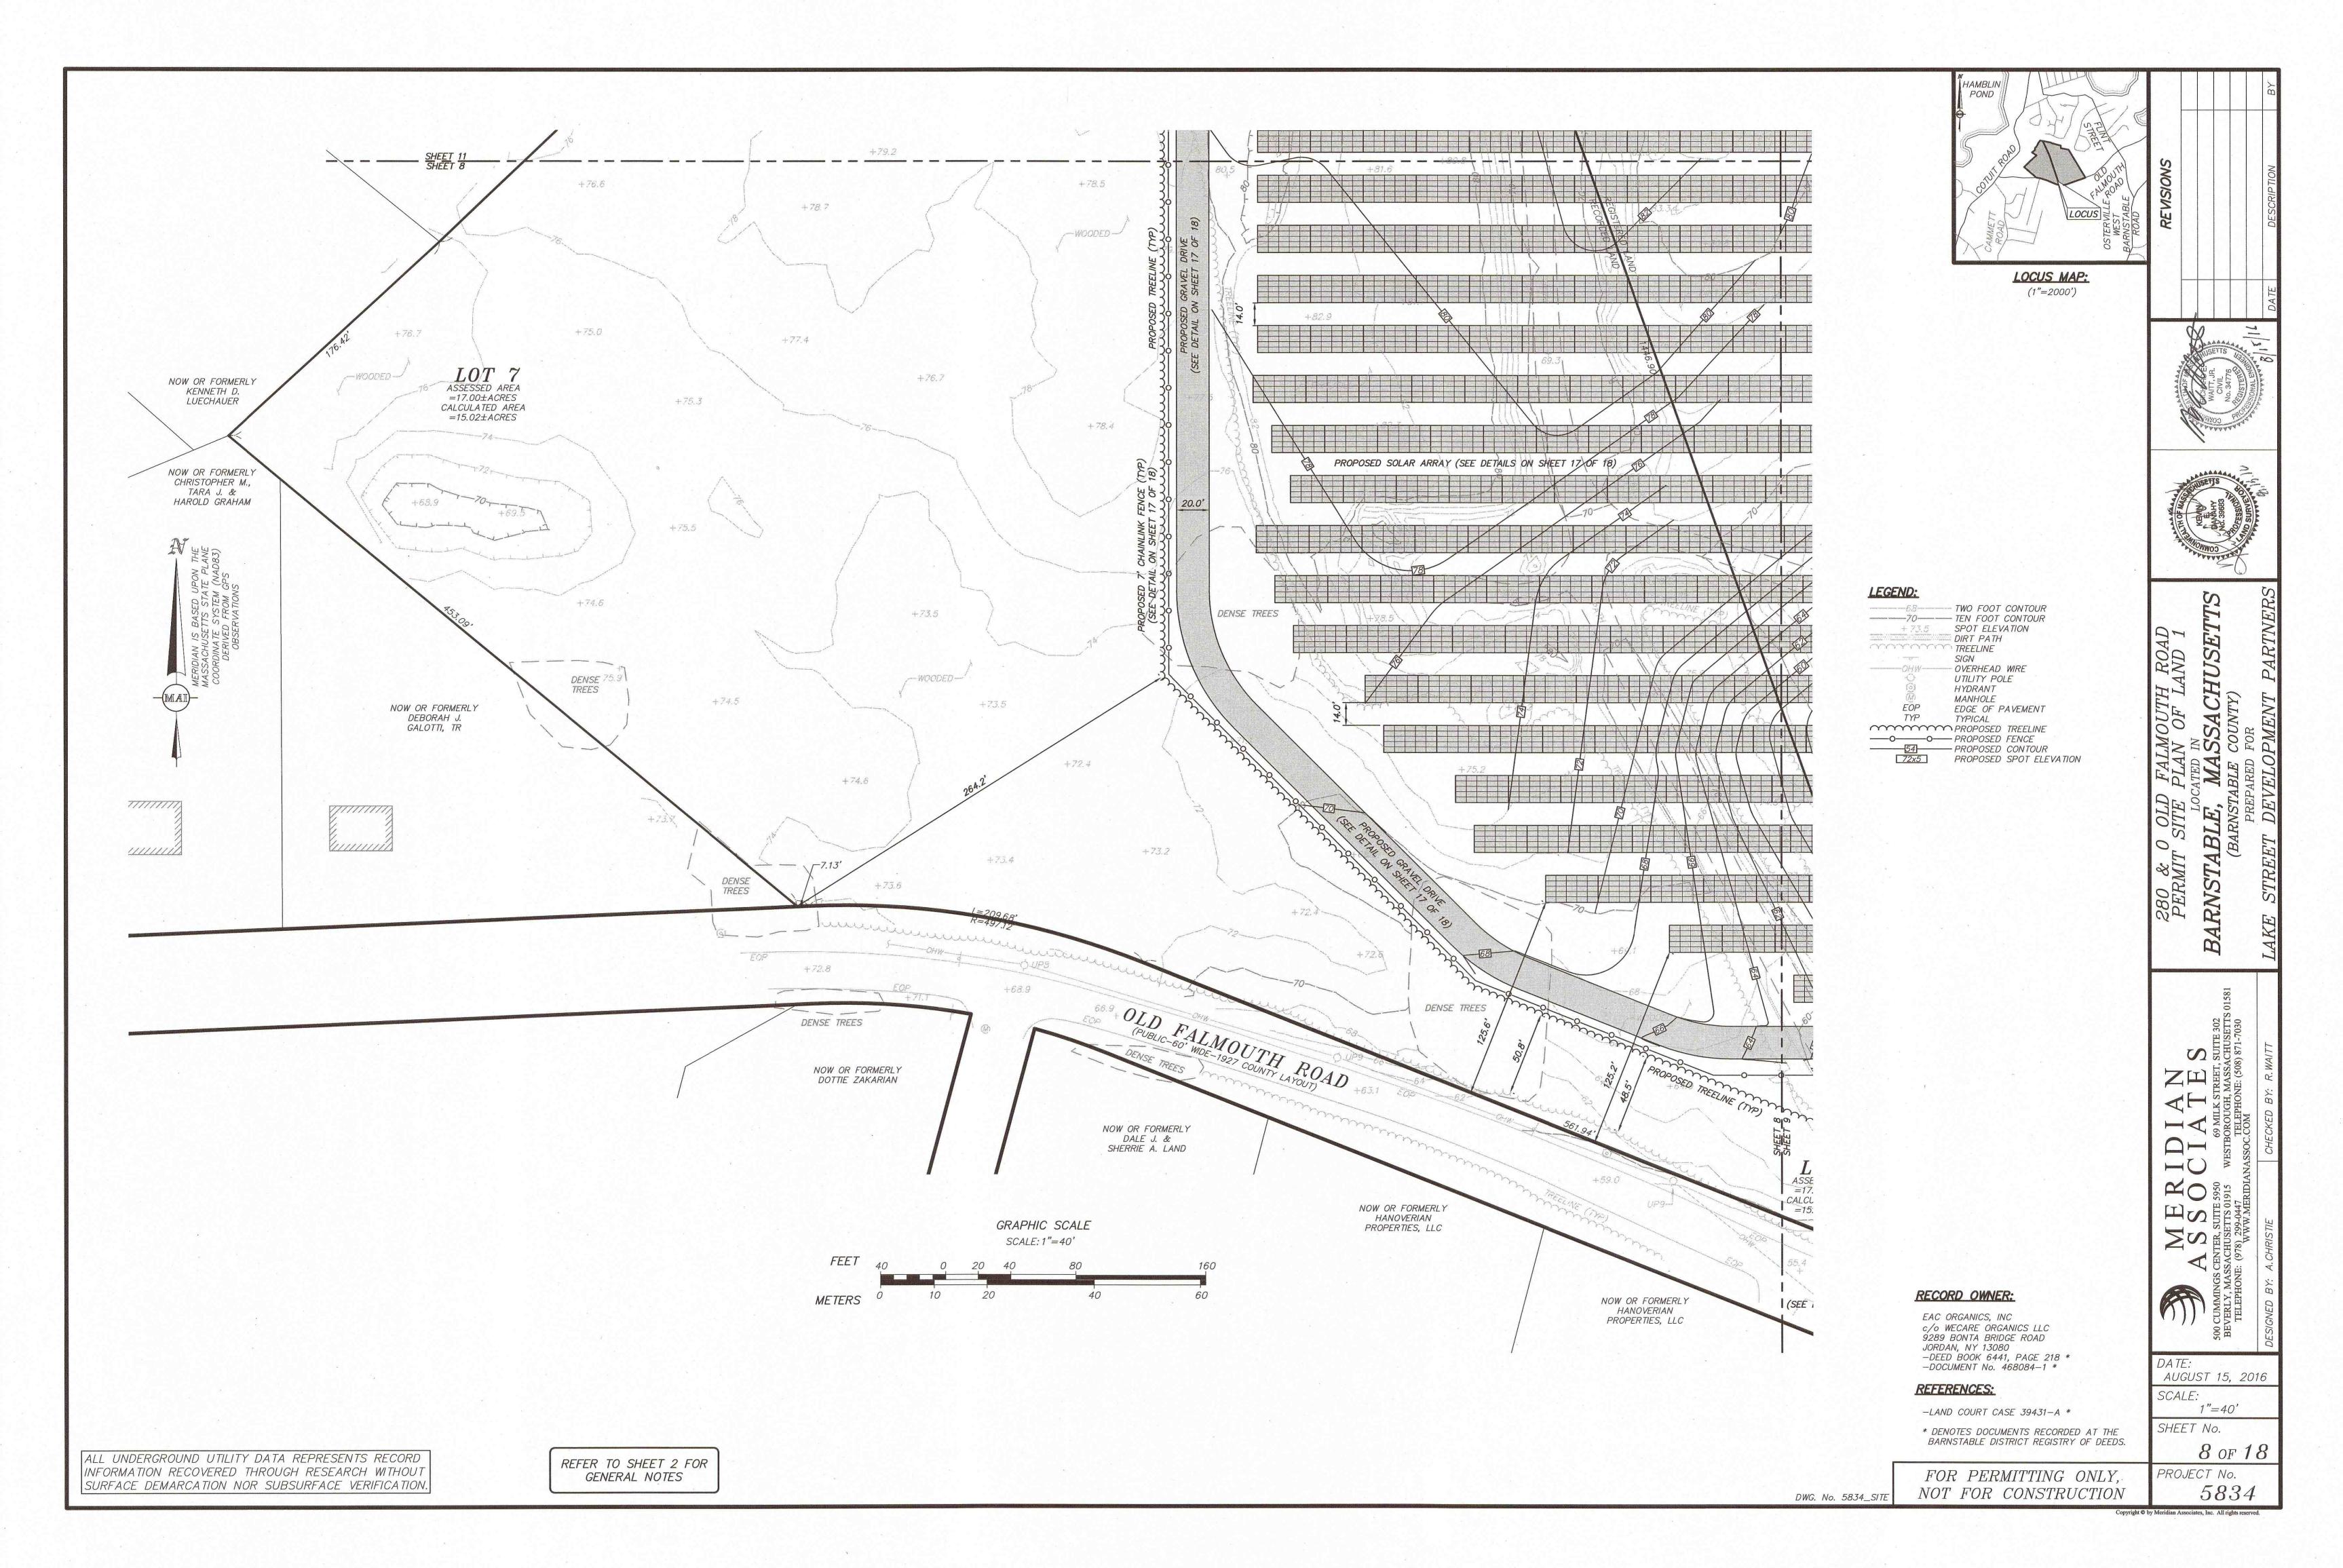
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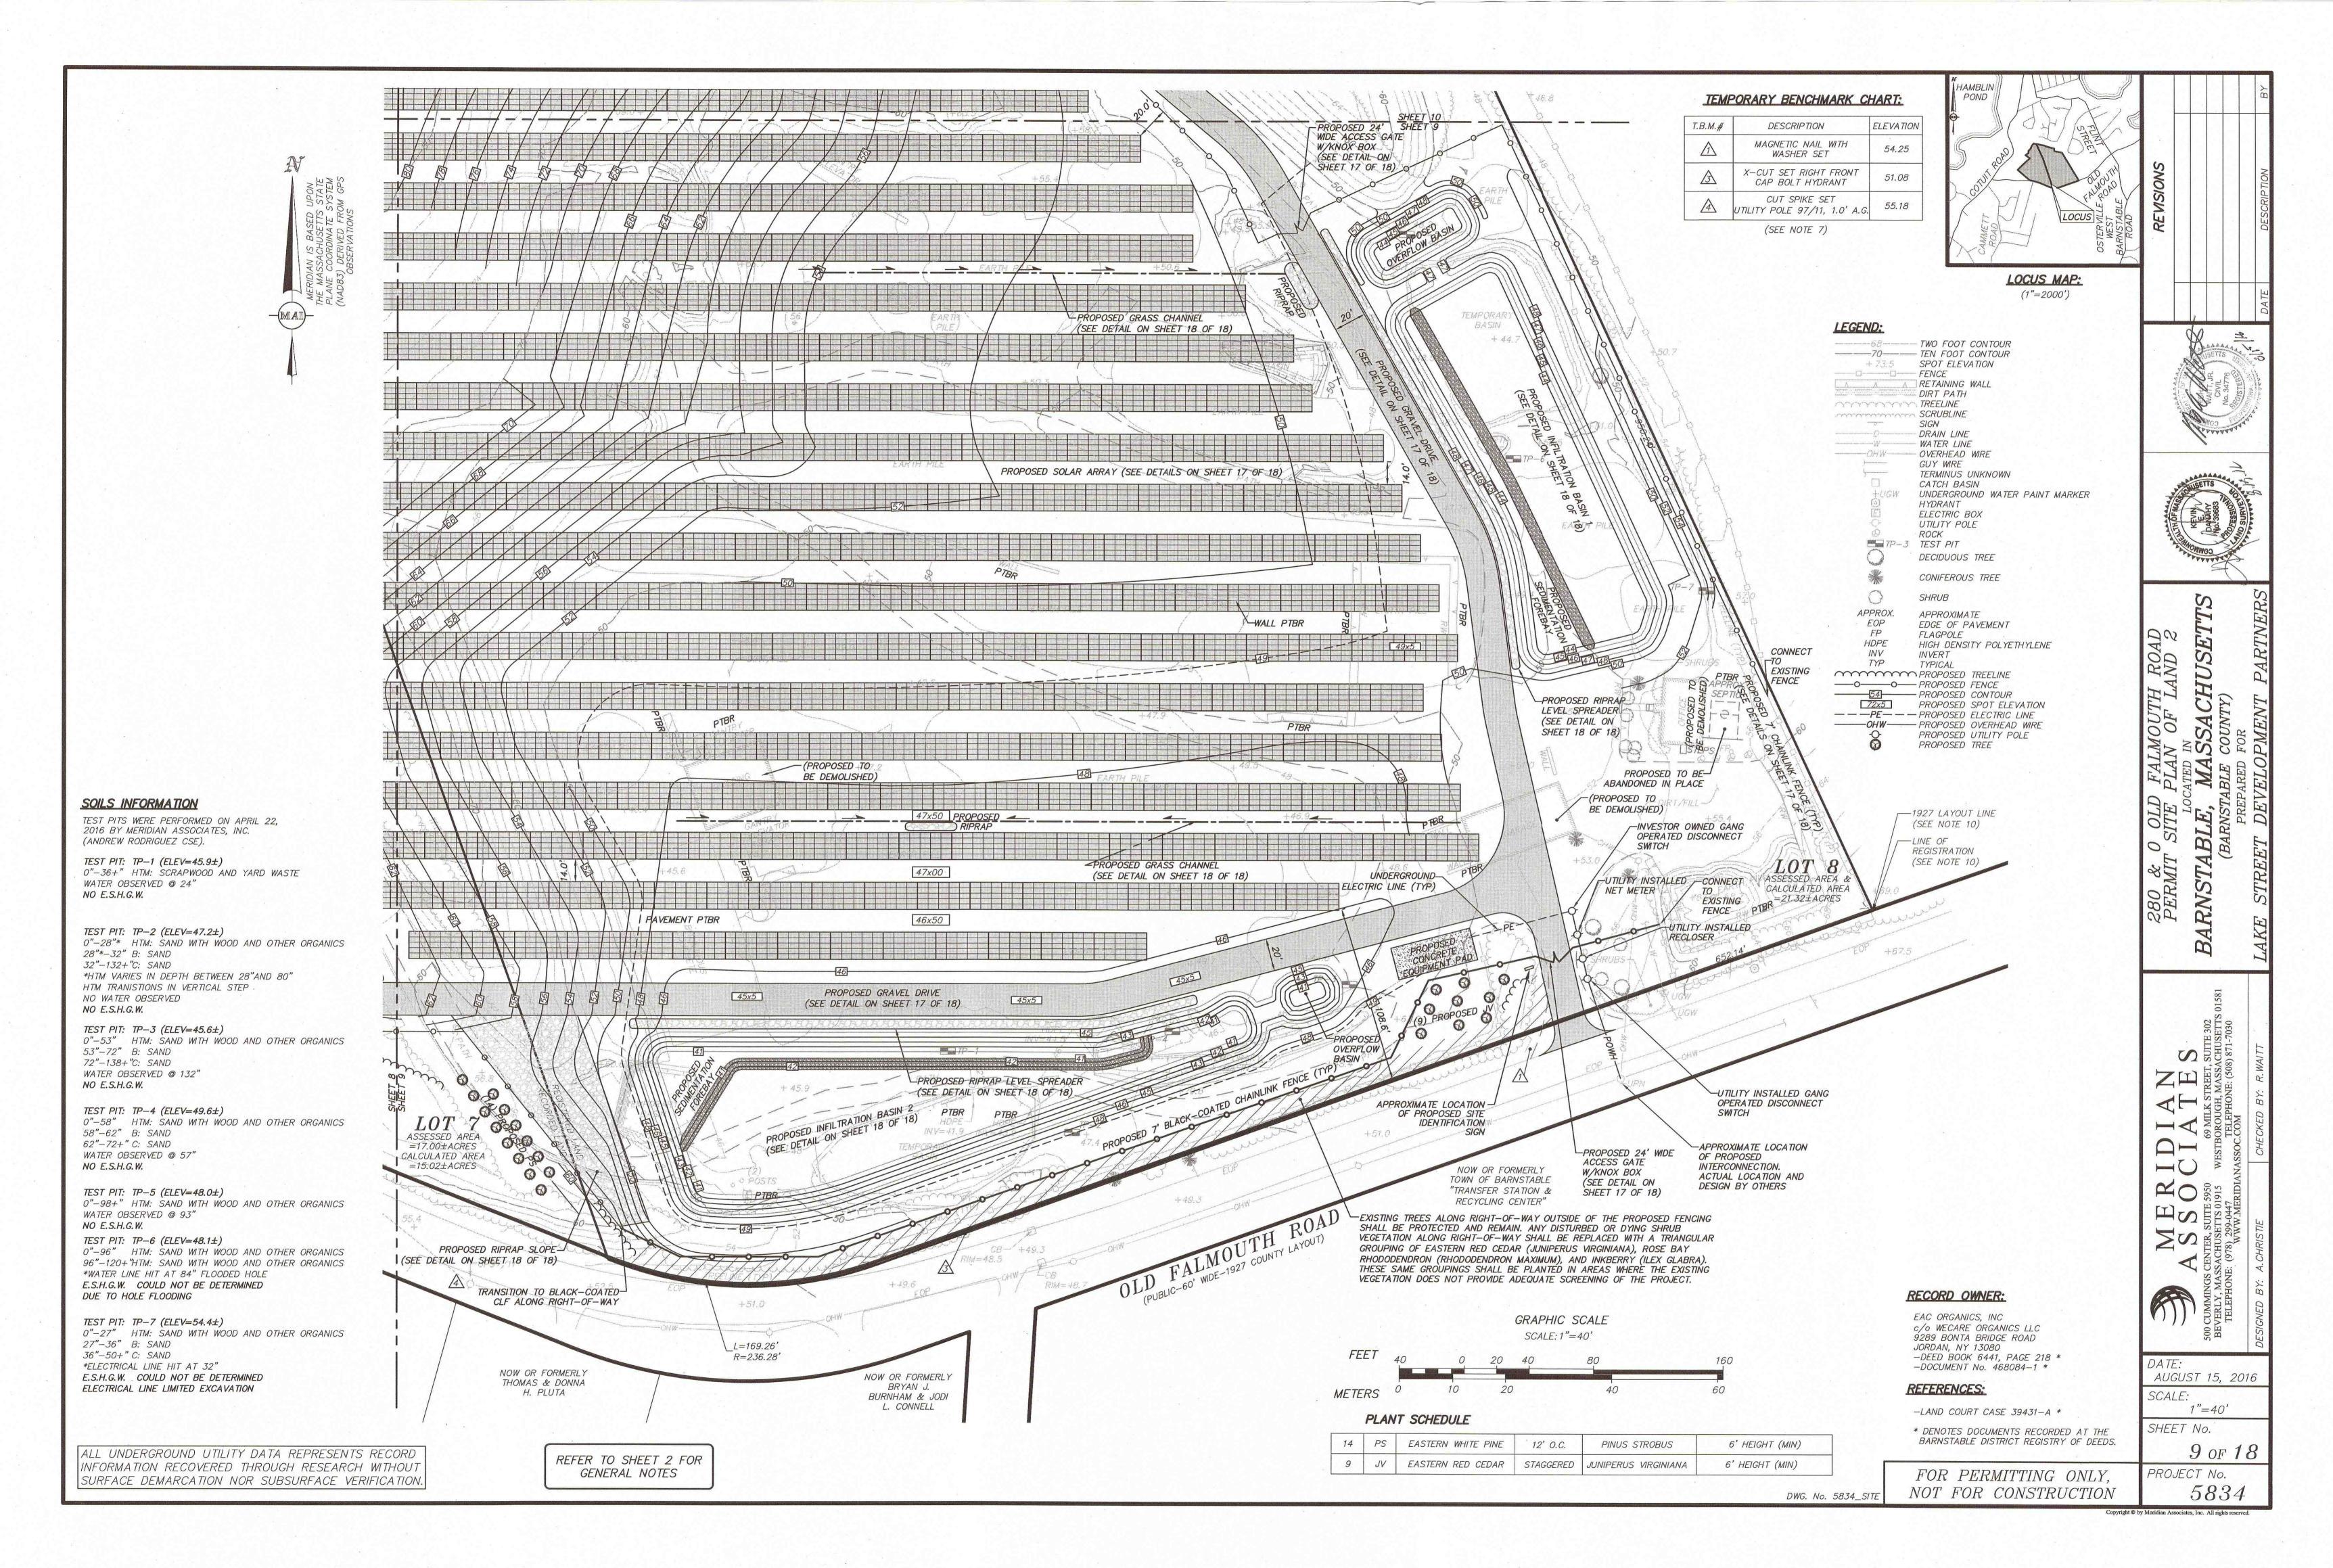
5 of 18

BARNSTABLE, (BARNST







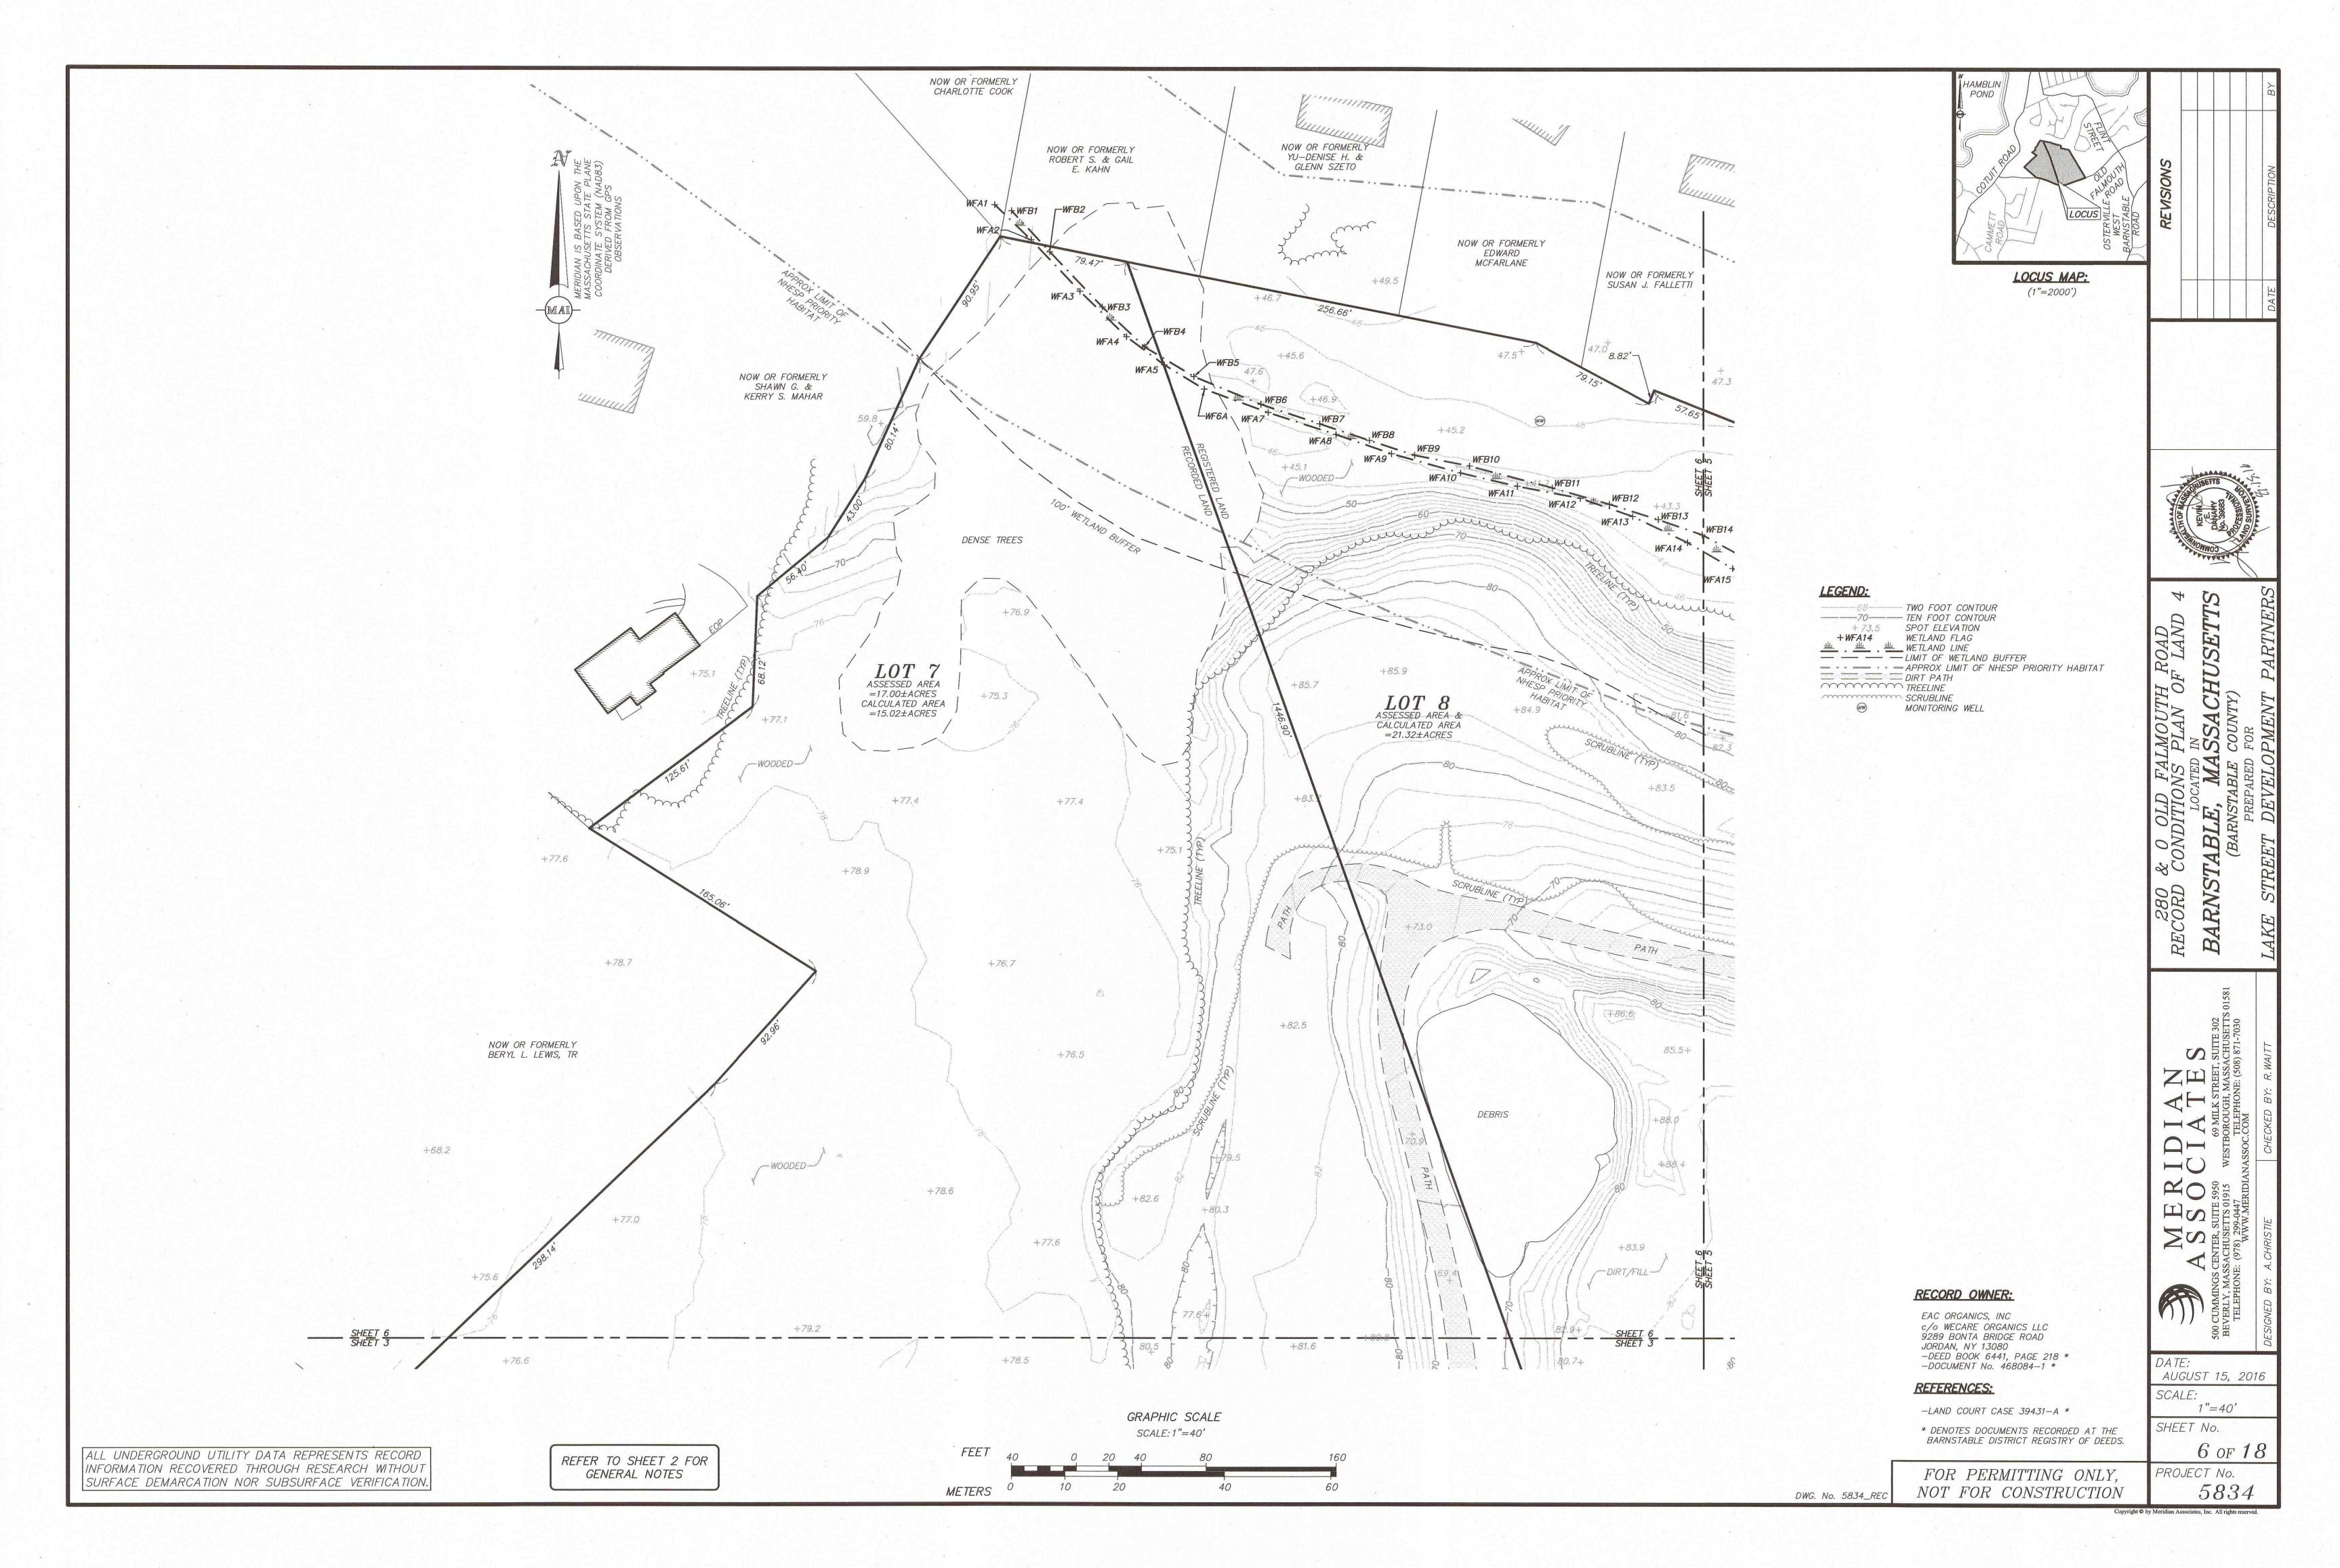

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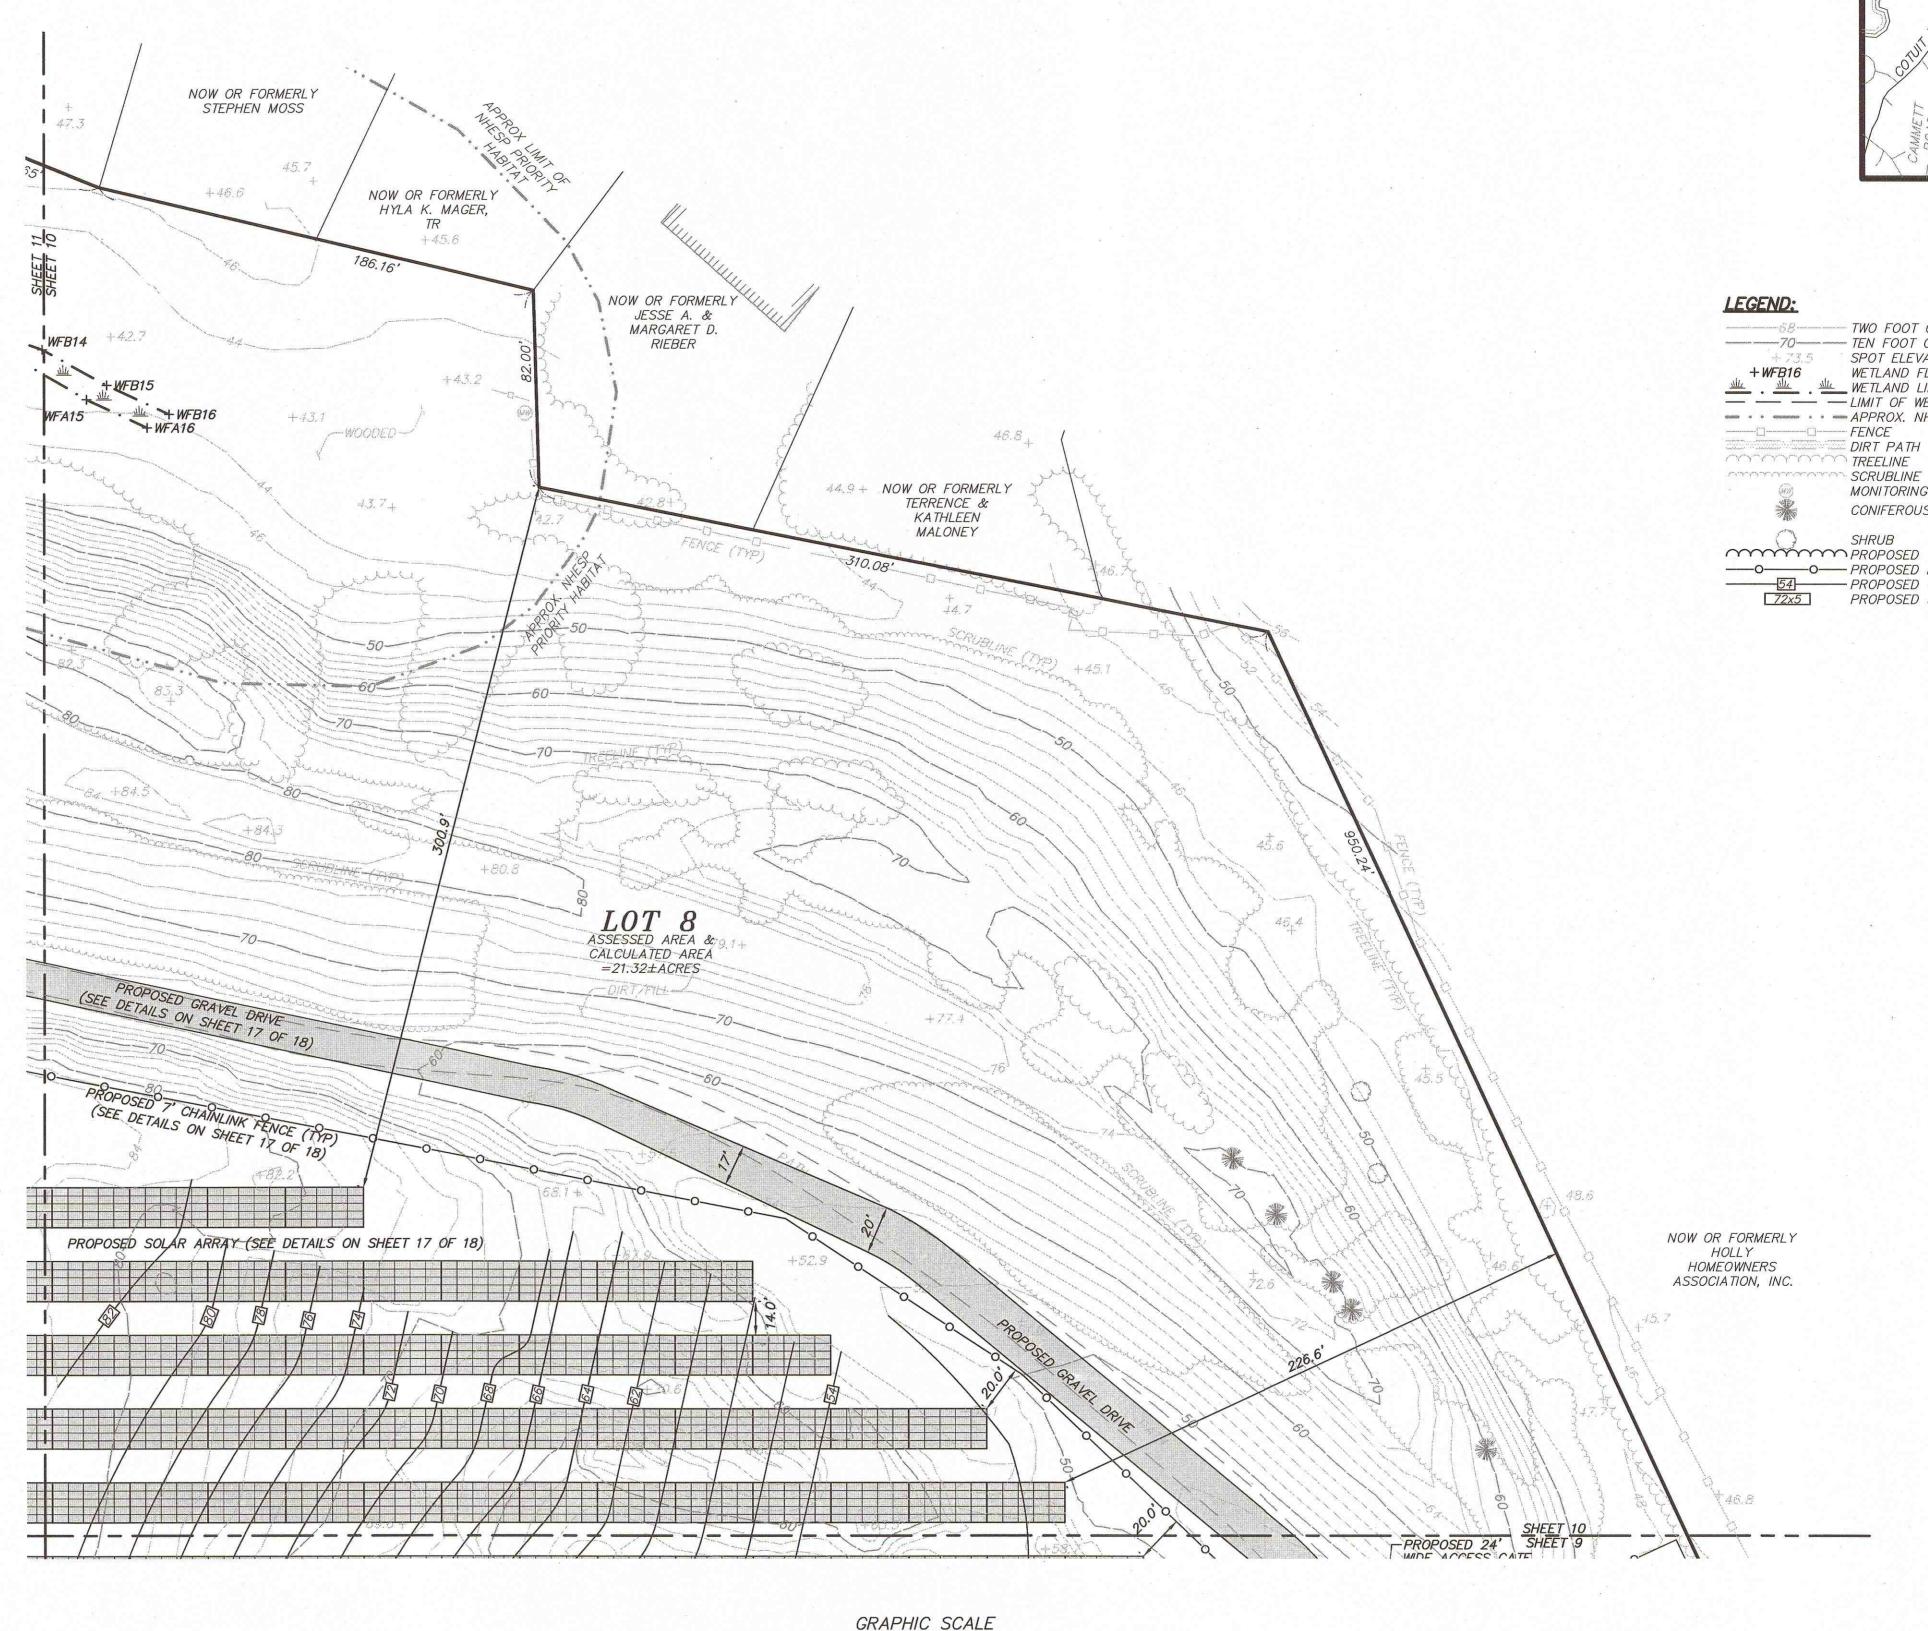
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FOR TITLE, SEE CERTIFICATE OF TITLE NO. 106718.



SCALE: 1"=40'

20 40

METERS

ALL UNDERGROUND UTILITY DATA REPRESENTS RECORD INFORMATION RECOVERED THROUGH RESEARCH WITHOUT SURFACE DEMARCATION NOR SUBSURFACE VERIFICATION.

REFER TO SHEET 2 FOR GENERAL NOTES

RECORD OWNER:

DWG. No. 5834_SITE

EAC ORGANICS, INC c/o WECARE ORGANICS LLC 9289 BONTA BRIDGE ROAD JORDAN, NY 13080 -DEED BOOK 6441, PAGE 218 * -DOCUMENT No. 468084-1 *

REFERENCES:


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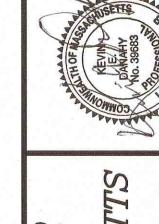
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TWO FOOT CONTOUR TEN FOOT CONTOUR + 73.5 SPOT ELEVATION + WFB16 WETLAND FLAG WETLAND LINE — — — LIMIT OF WETLAND BUFFER - - - - - APPROX. NHESP PRIORITY HABITAT

TREELINE SCRUBLINE MONITORING WELL CONIFEROUS TREE

PROPOSED TREELINE PROPOSED CONTOUR
72x5 PROPOSED SPOT ELEVATION




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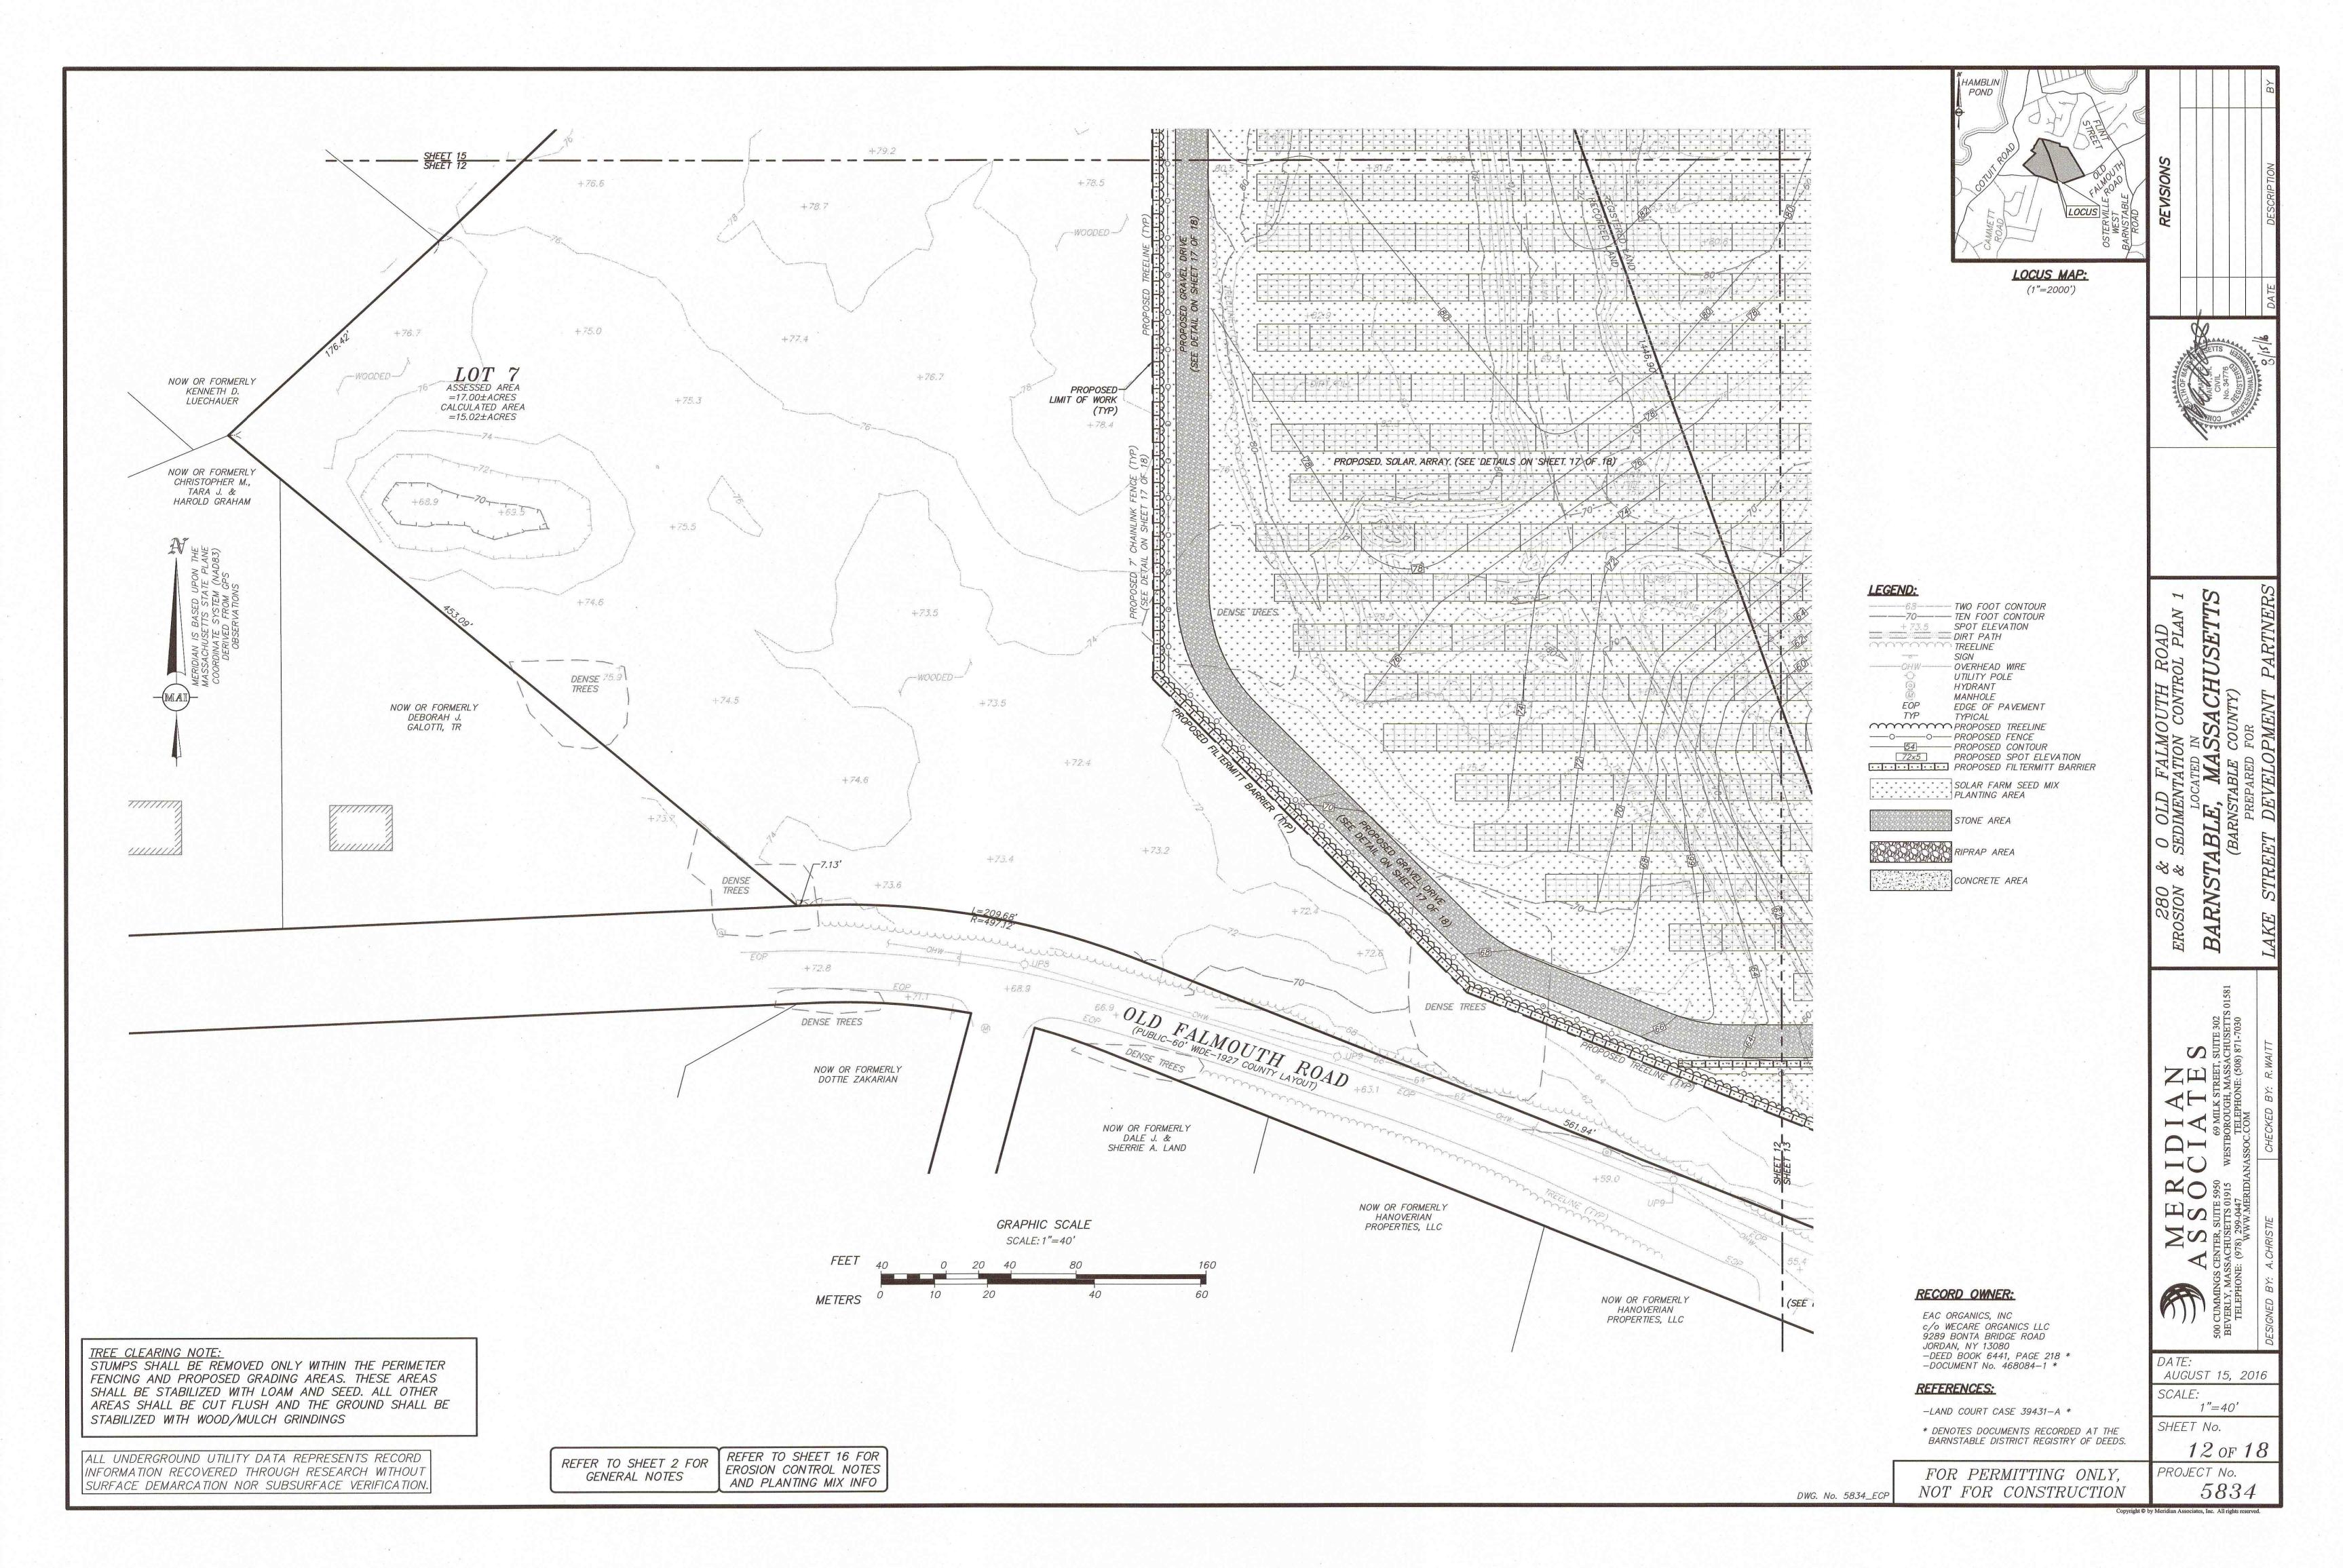
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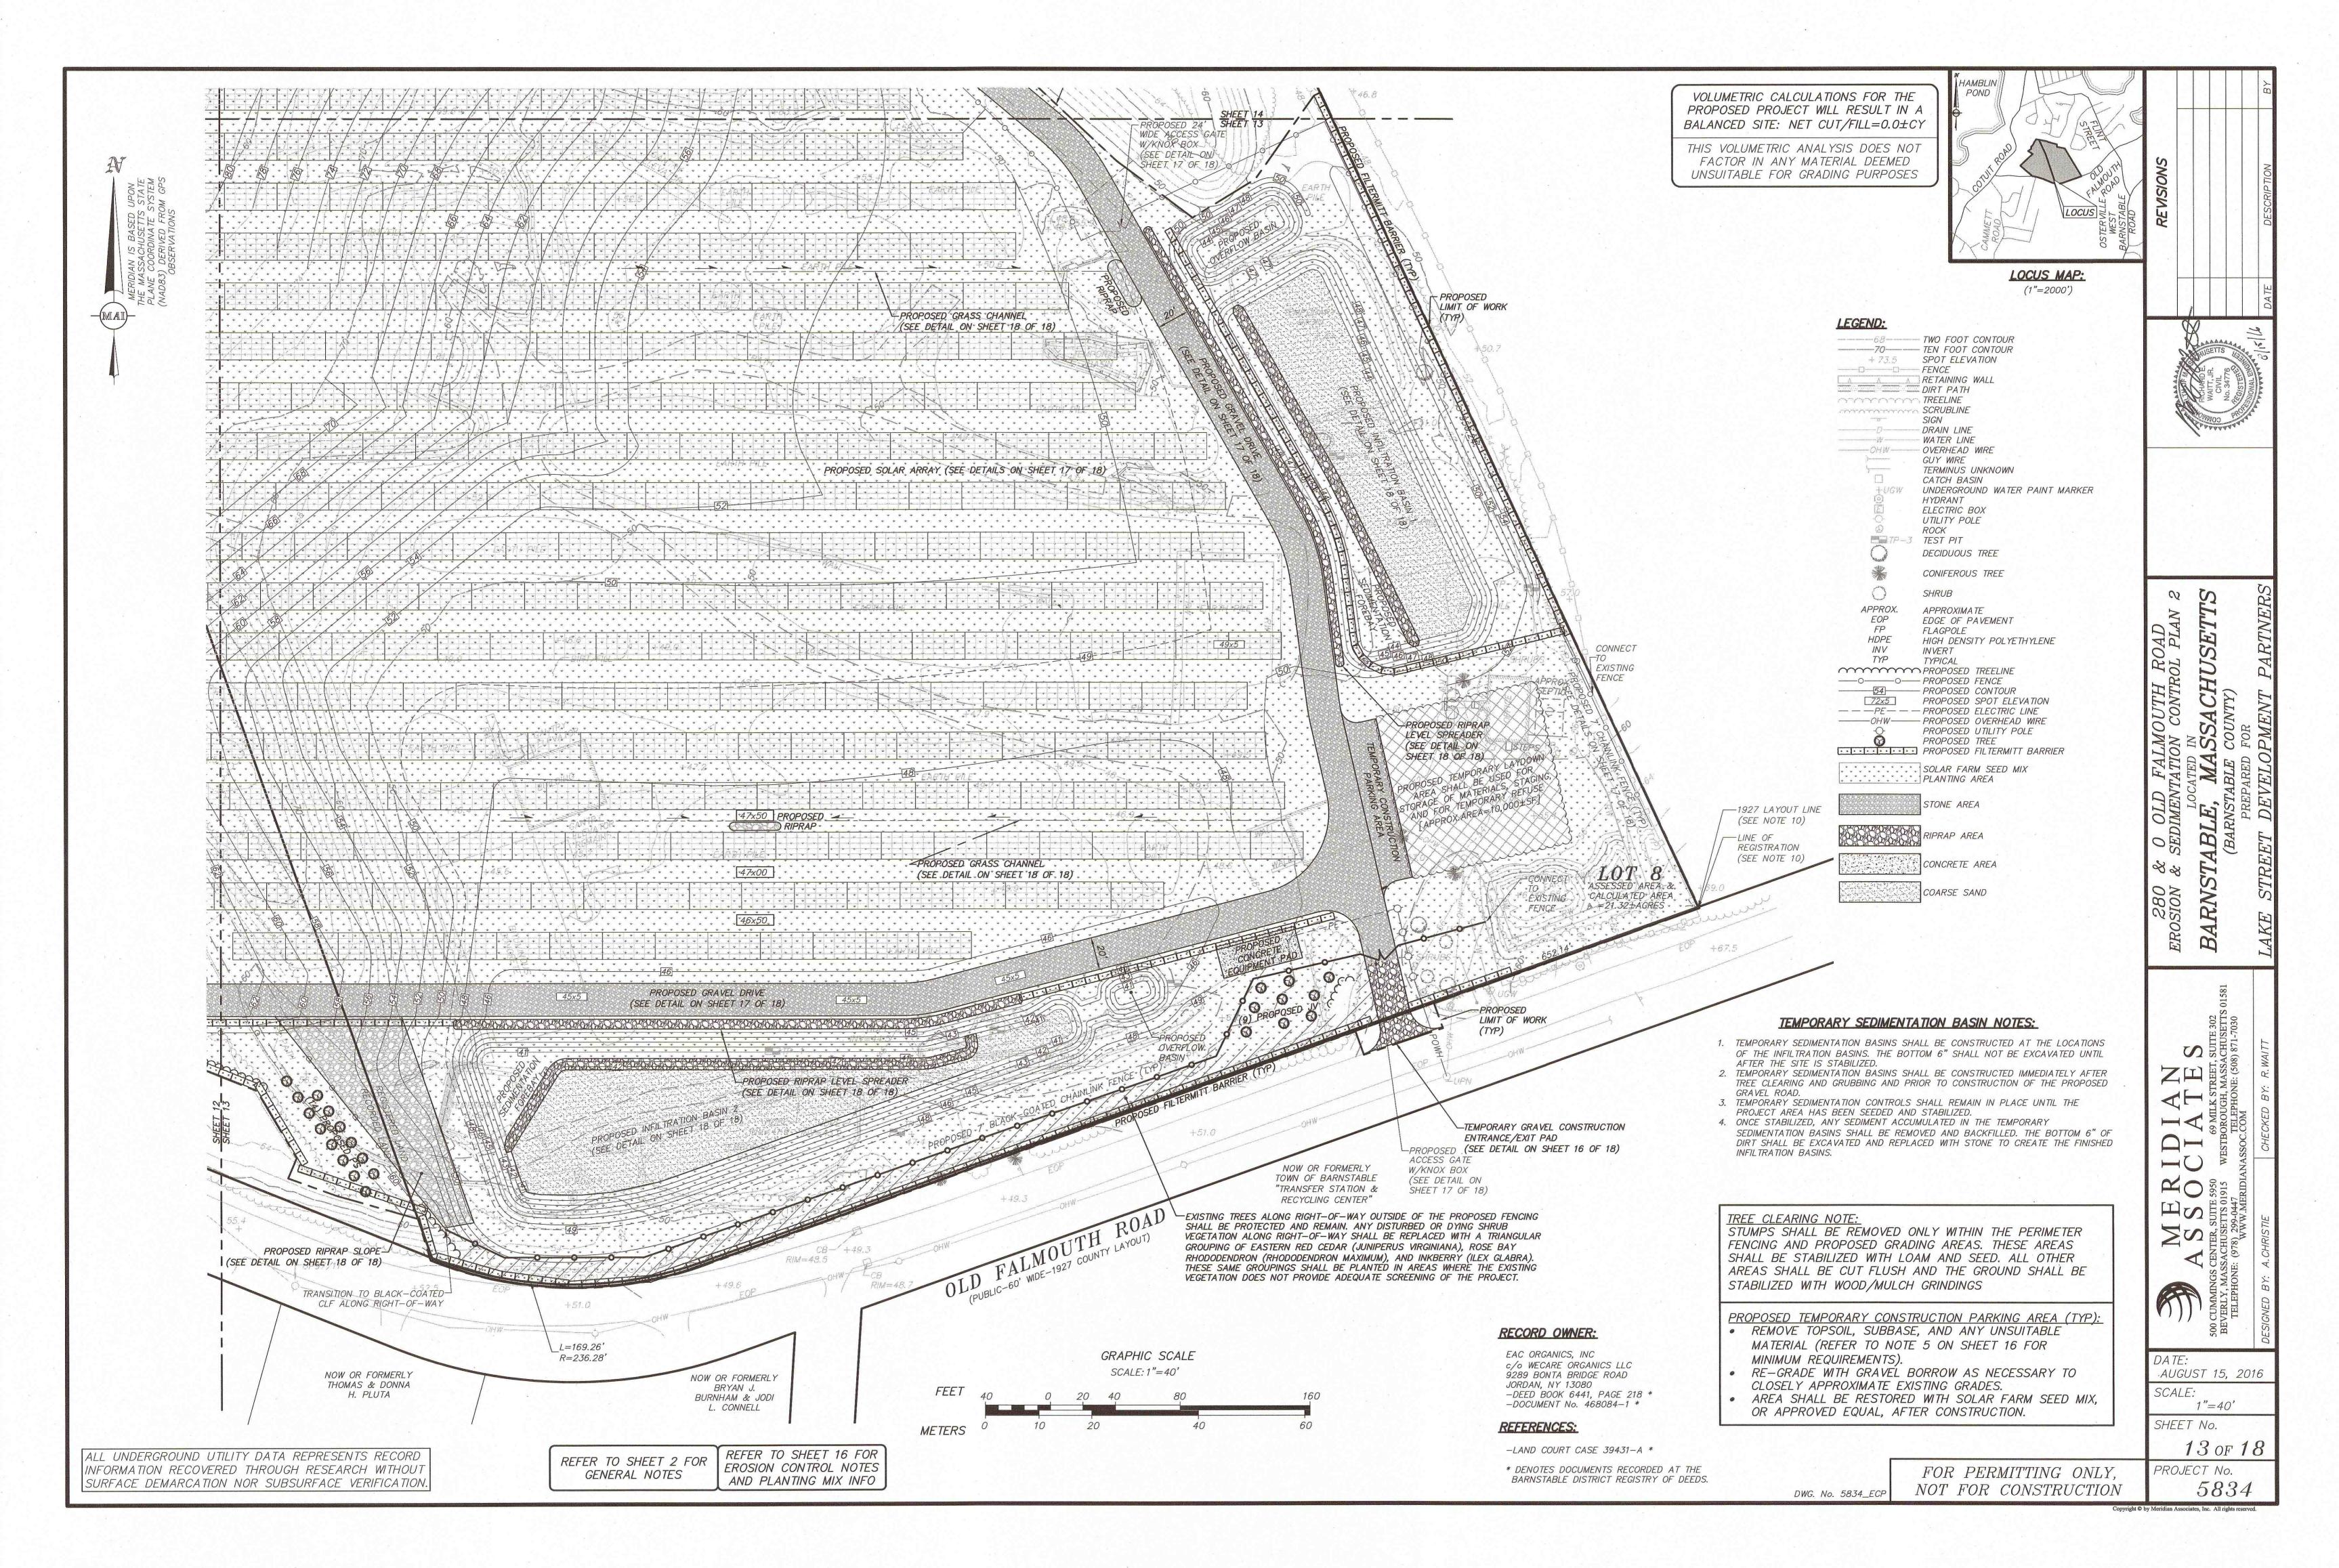
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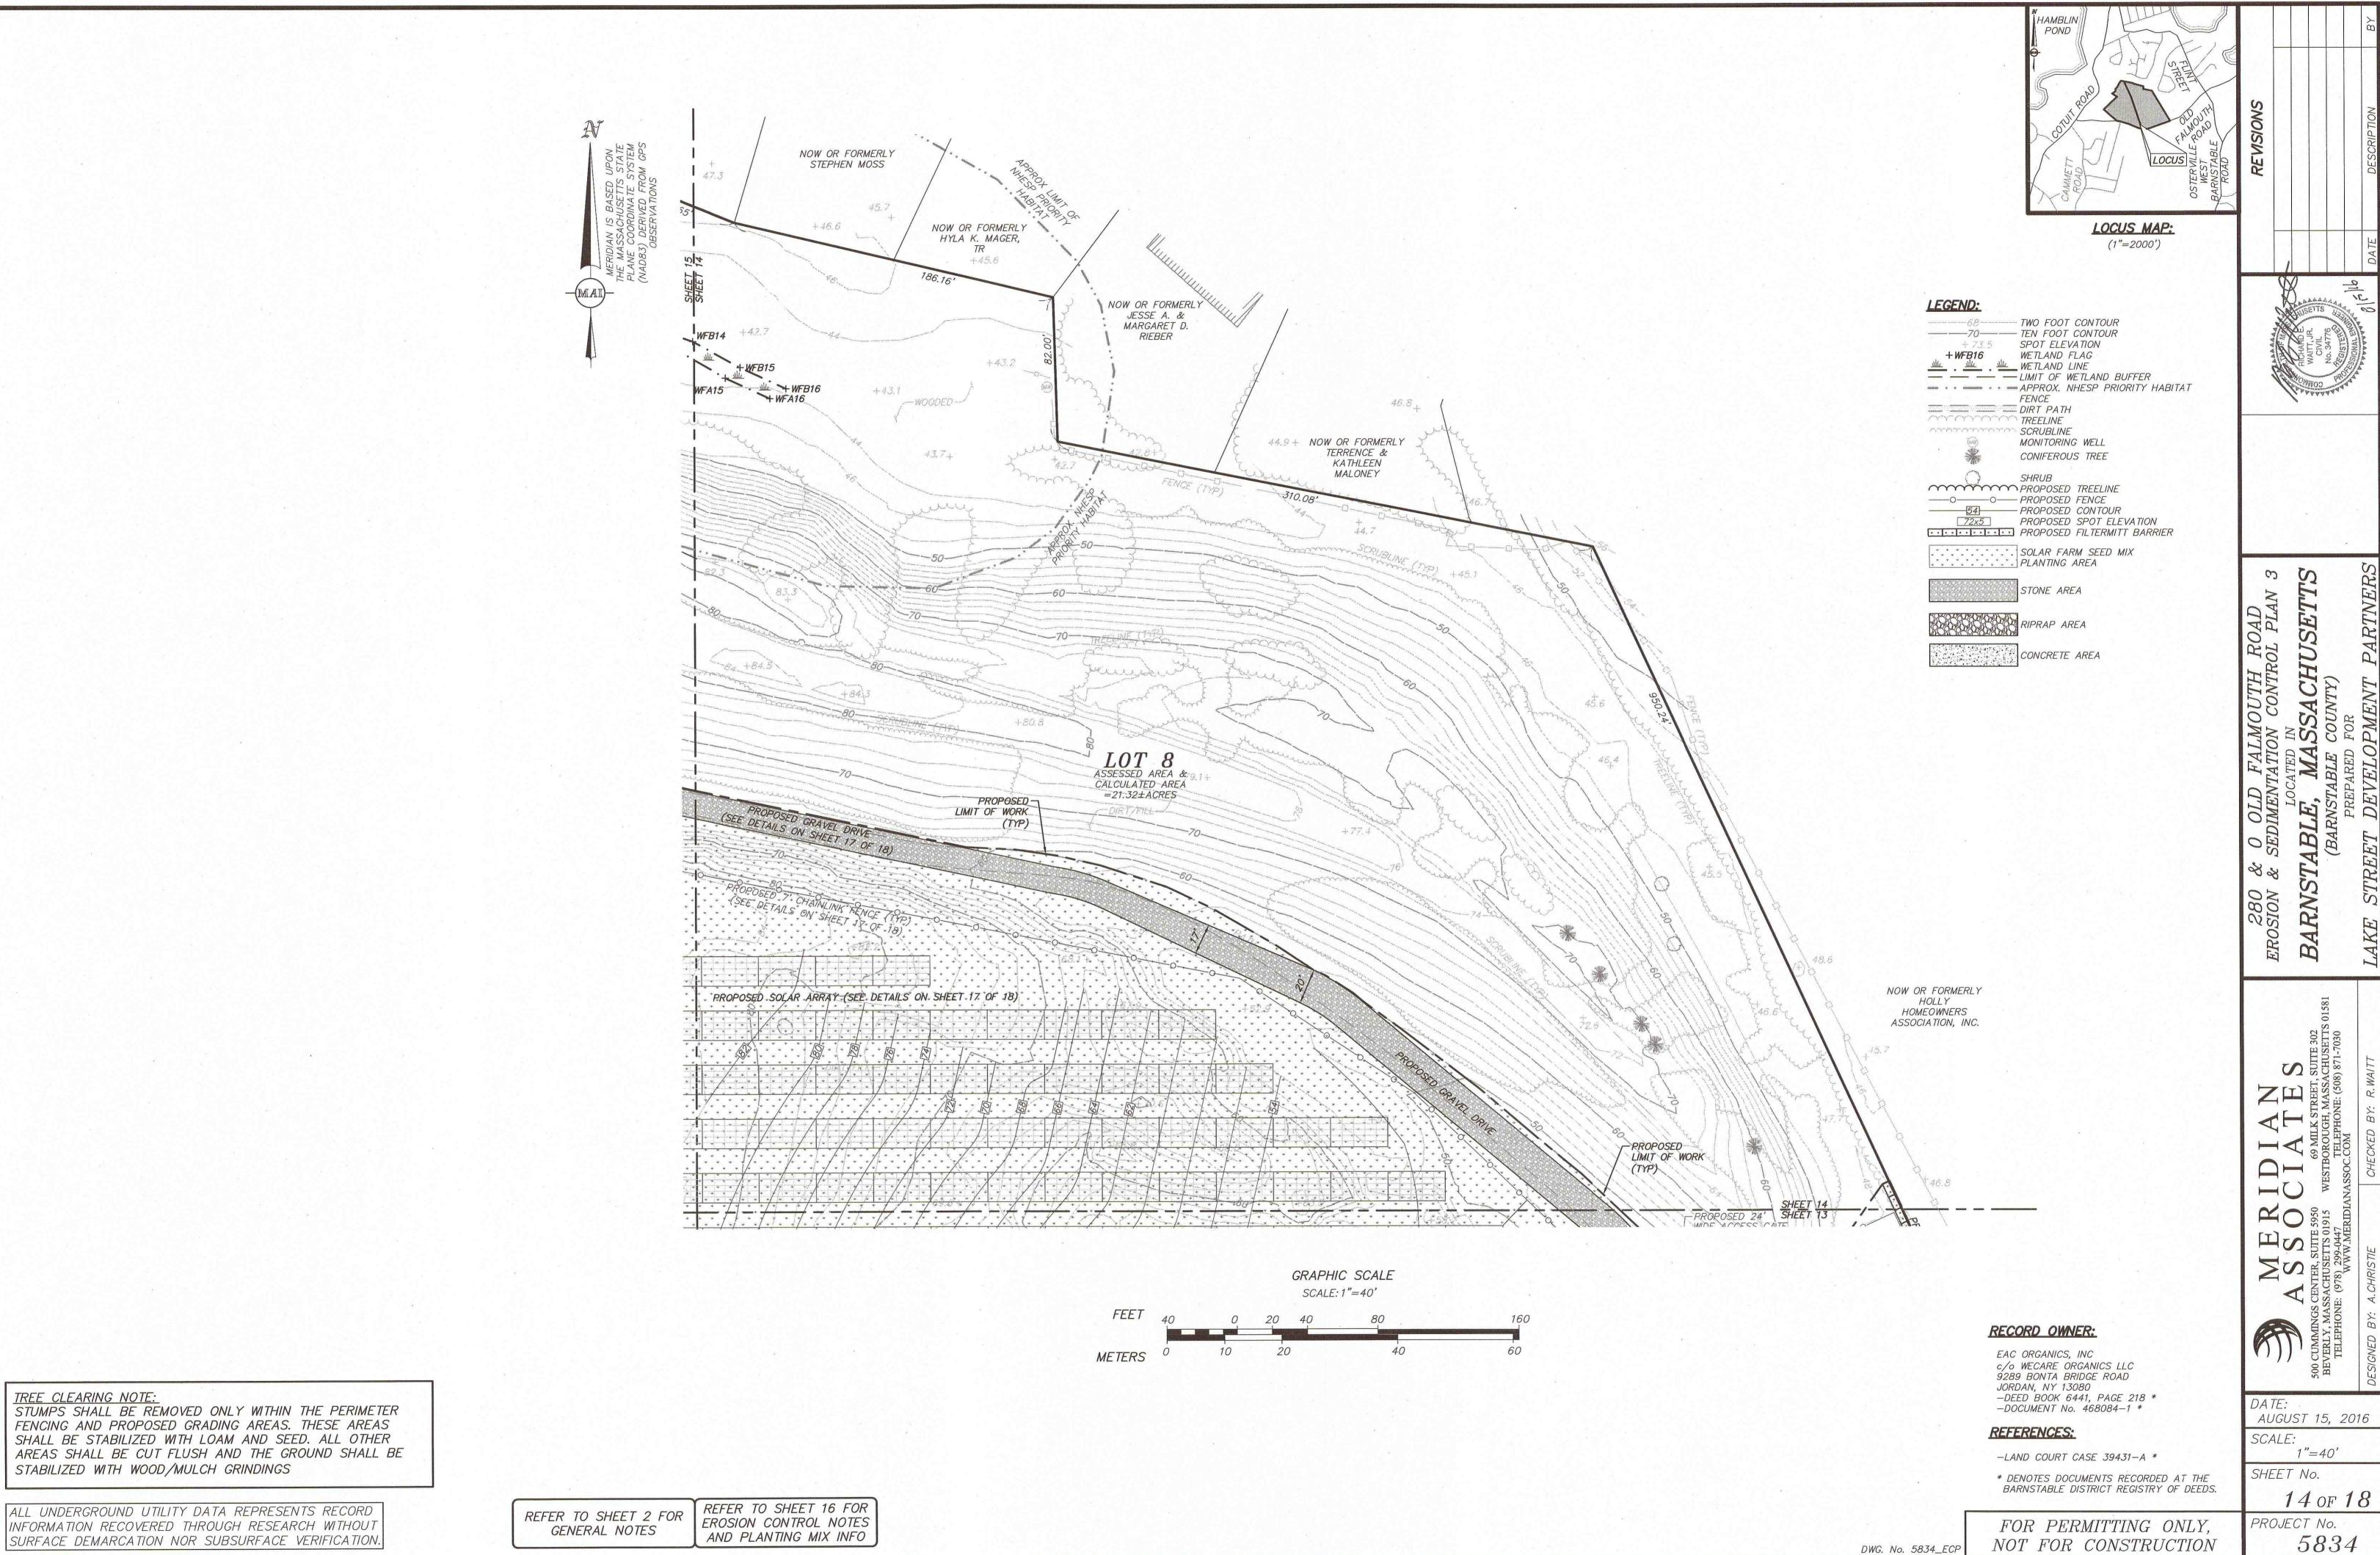
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PROJECT No. 5834

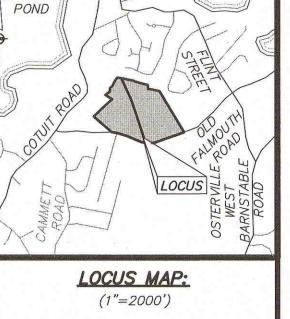







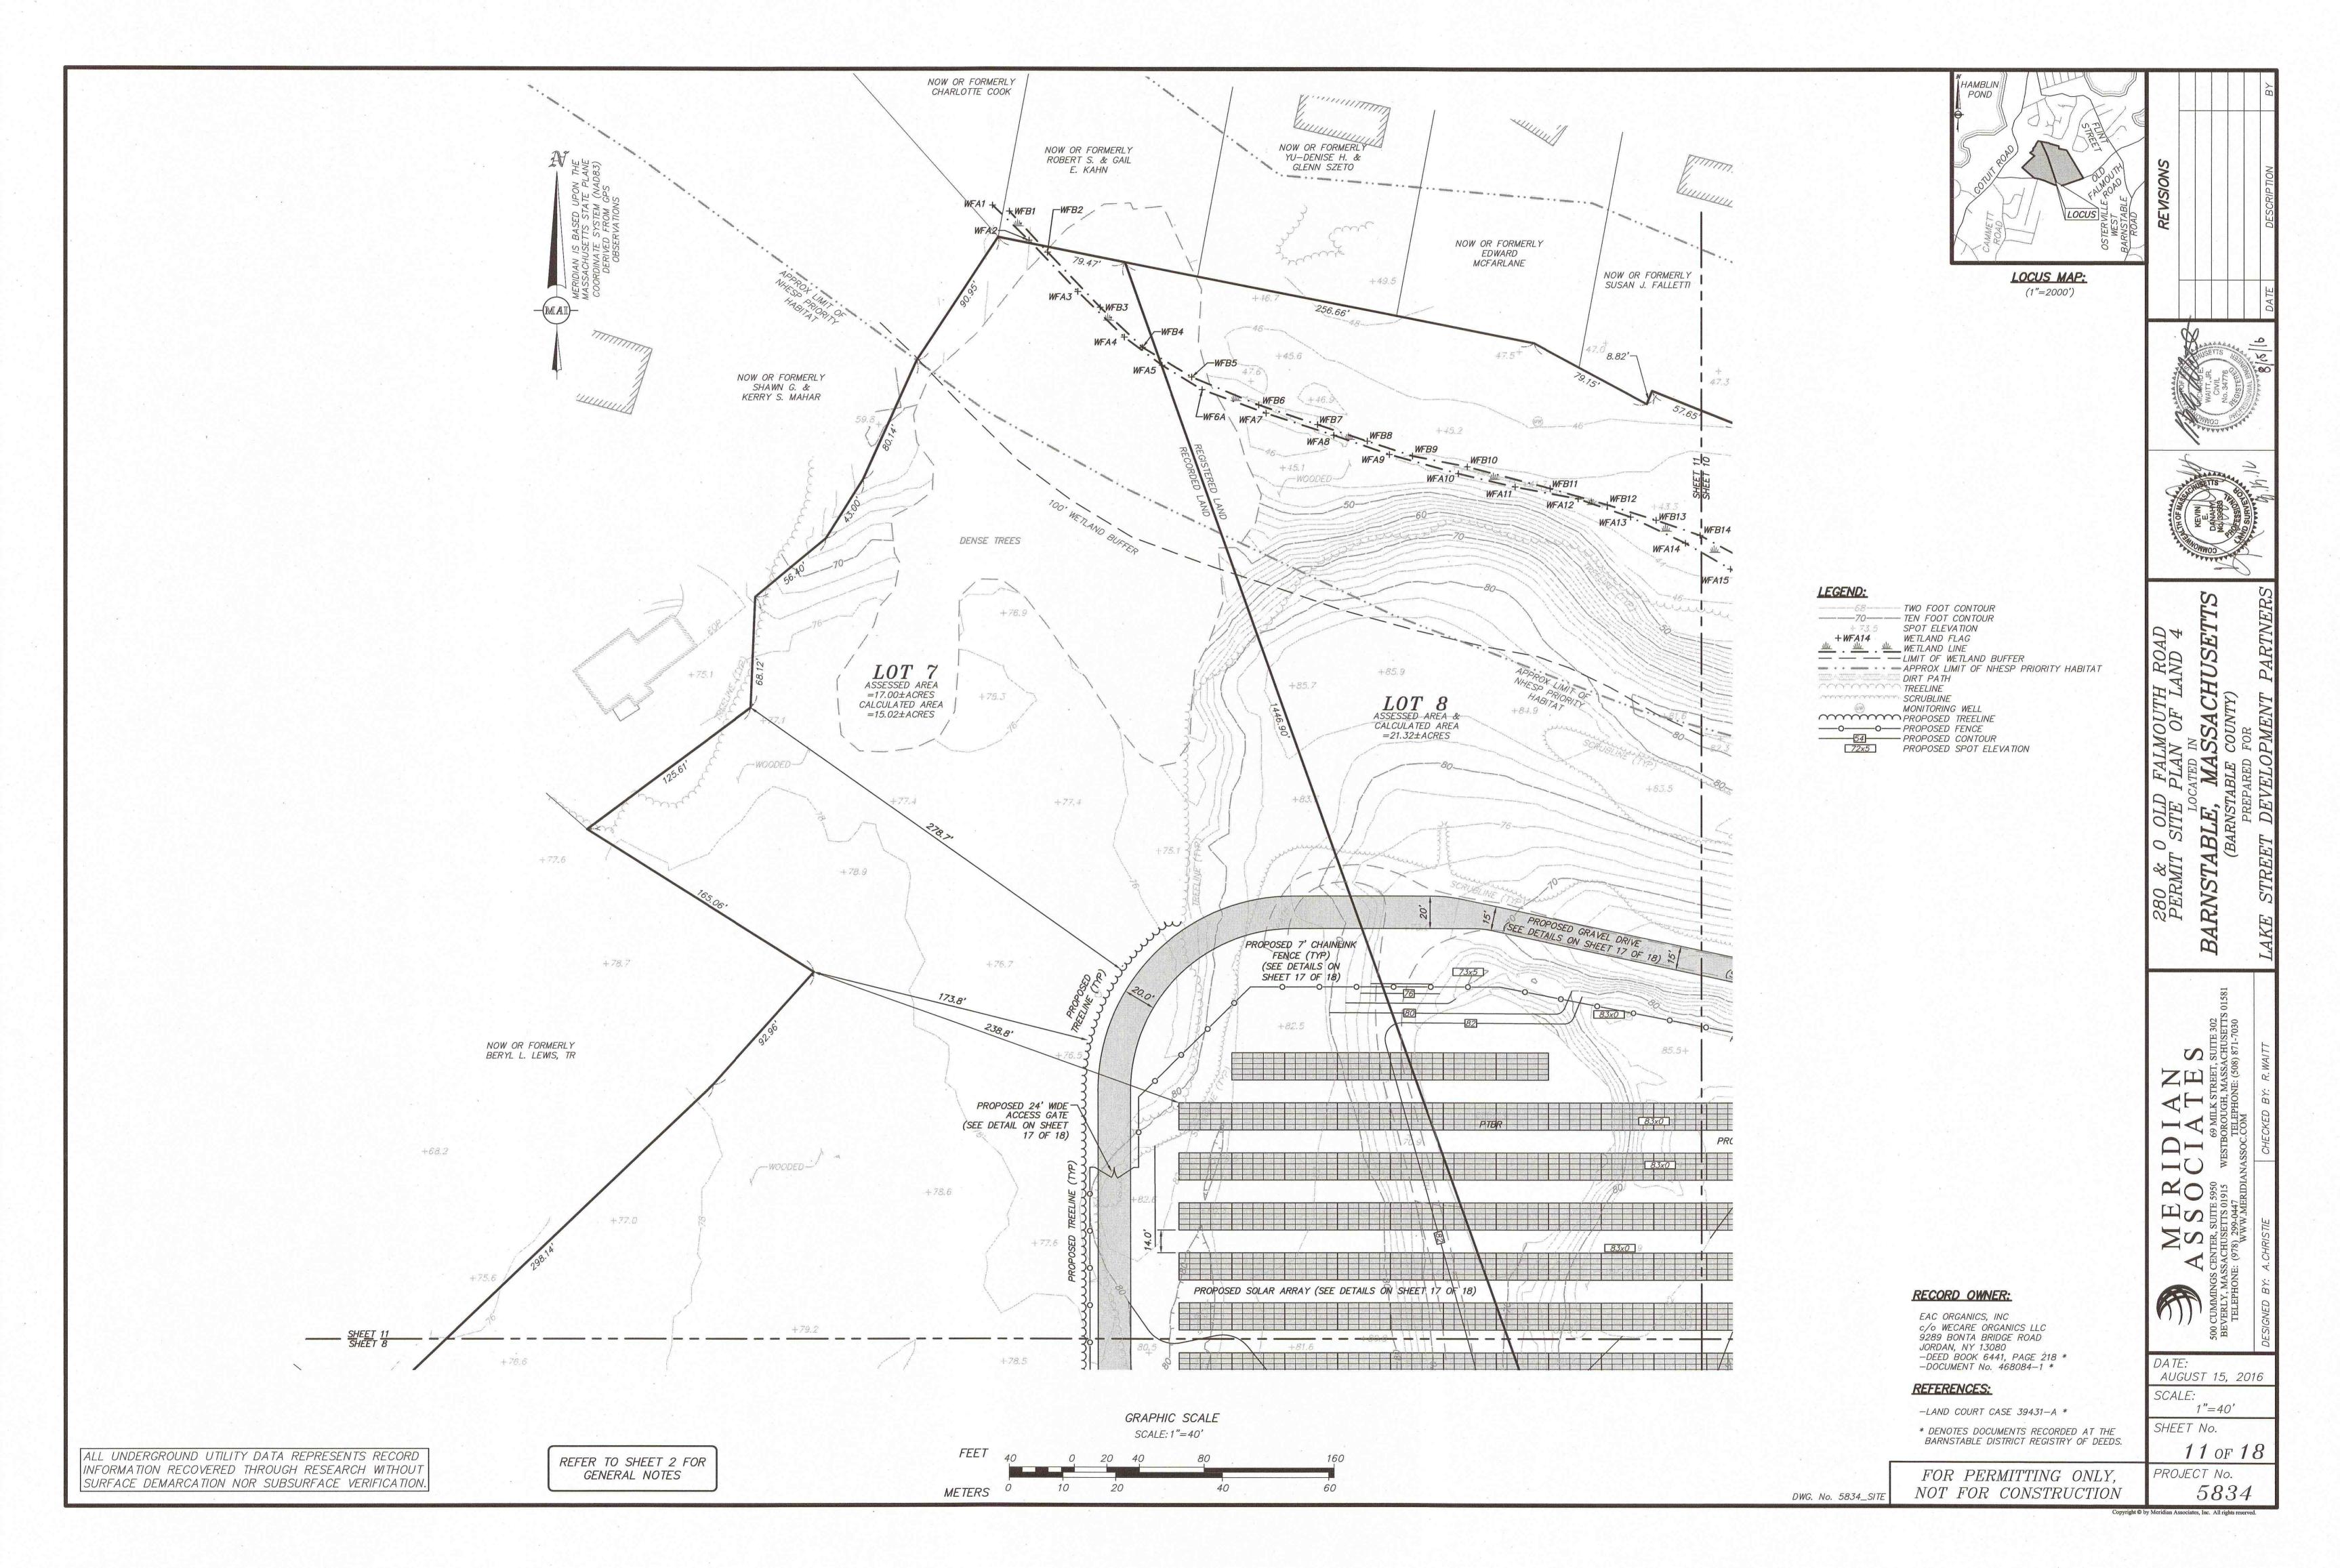

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- 1. THE TOPOGRAPHY, SITE DETAIL & SURFACE IMPROVEMENTS DEPICTED HEREON WERE OBTAINED FROM AERIAL PHOTOGRAMMETRIC MAPPING CONDUCTED BY COL-EAST, INC. DATED MARCH 30, 2007, AND SUPPLEMENTED BY A LIMITED INSTRUMENT SURVEY CONDUCTED BY MERIDIAN ASSOCIATES, INC. (MAI) BETWEEN FEBRUARY 11-MARCH 31, 2016.
- 2. EXISTING GROUND WITHIN THE PROPOSED CHAINLINK FENCE TO BE CLEARED, STUMPED AND RE-GRADED PER THE SITE PLANS. RE-VEGETATION OF THE SITE SHALL BE ESTABLISHED WITH A LOW GROWTH GROUND COVER, SOLAR FARM SEED MIX, OR APPROVED EQUAL, AND A MASS DOT SEED MIX FOR SHOULDERS AND SLOPES IN THE AREAS DEPICTED ON THE EROSION AND SEDIMENTATION CONTROL PLANS.
- 3. THE PROPOSED LIMIT OF WORK LINE ALSO DEPICTS THE EXTENT OF TREE CLEARING TO BE PERFORMED ON THE PROJECT SITE. NO TREES OUTSIDE THE DESIGNATED LIMIT OF WORK LINE ARE TO BE REMOVED BY THE
- 4. COMMON FILL (SITE GRADING AREAS) SHALL CONSIST OF MINERAL SOIL SUBSTANTIALLY FREE FROM ORGANIC MATERIALS, LOAM, WOOD TRASH AND OTHER OBJECTIONABLE MATERIALS WHICH MAY BE COMPRESSIBLE OR WHICH CANNOT BE PROPERLY COMPACTED. SELECT COMMON FILL SHALL NOT CONTAIN STONES LARGER THAN 2-IN. IN LARGEST DIAMETER AND SHALL HAVE A MAXIMUM OF 75% PASSING THE NO. 40 SIEVE AND A MAXIMUM OF 20% PASSING THE NO. 200 SIEVE. SELECT COMMON FILL SHALL NOT CONTAIN GRANITE BLOCKS, BROKEN CONCRETE, MASONRY RUBBLE OR OTHER SIMILAR MATERIALS. IT SHALL HAVE PHYSICAL PROPERTIES SUCH THAT IT CAN BE READILY SPREAD AND COMPACTED DURING FILLING. SNOW, ICE AND FROZEN SOIL WILL NOT BE PERMITTED. SOIL EXCAVATED FROM THE STRUCTURE AREAS AND WHICH MEETS THE ABOVE REQUIREMENTS MAY BE USED.
- 5. ORDINARY FILL SHALL BE WELL GRADED, NATURAL INORGANIC SOIL, FREE OF ORGANIC OR OTHER WEAK OR COMPRESSIBLE MATERIALS, FROZEN MATERIALS, AND OF STONES LARGER THAN TWO THIRDS (3/3) THE LIFT THICKNESS. IT SHALL BE OF SUCH NATURE AND CHARACTER THAT IT CAN BE COMPACTED TO THE SPECIFIED DENSITIES IN A REASONABLE LENGTH OF TIME. IT SHALL BE FREE OF PLASTIC CLAY, OF ALL MATERIALS SUBJECT TO DECAY, DECOMPOSITION, OR DISSOLUTION, AND OF CINDERS OR OTHER MATERIALS THAT WILL CORRODE PIPING OR OTHER METAL. IT SHALL HAVE A MINIMUM DRY DENSITY OF NOT LESS THAN 120 POUNDS PER CUBIC FOOT. MATERIAL FROM EXCAVATION ON THE SITE MAY BE USED AS ORDINARY FILL IF IT MEETS THE ABOVE REQUIREMENTS. ORDINARY FILL SHALL HAVE A MAXIMUM OF 60% PASSING THE #40 SIEVE, AND A MAXIMUM OF 20% PASSING THE #200 SIEVE. IT SHOULD NOT CONTAIN BROKEN CONCRETE," MASONRY RUBBLE OR OTHER SIMILAR MATERIALS, AND SHALL HAVE PHYSICAL PROPERTIES SUCH THAT IT CAN BE READILY SPREAD AND COMPACTED DURING FILLING. SNOW, ICE AND FROZEN SOIL SHALL NOT BE PERMITTED.
- 6. SELECT COMMON FILL (ROADWAY AREAS) SHALL BE PLACED IN LAYERS HAVING A MAXIMUM THICKNESS OF 8 IN. MEASURED BEFORE COMPACTION. EACH LAYER OF FILL SHALL BE COMPACTED TO AT LEAST 95 PERCENT OF MAXIMUM DRY DENSITY DETERMINED BY THE ASTM D1557. COMPACTION OF STRUCTURAL FILL SHALL CONSIST OF FULLY LOADED TEN WHEEL TRUCKS, A TRACTOR DOZER WEIGHING AT LEAST 30,000 LBS AND OPERATED AT FULL SPEED, A HEAVY VIBRATORY ROLLER, OR OTHER METHOD ONLY AS APPROVED BY THE ENGINEER, COMPACTION OF SELECT COMMON FILL IN CONFINED AREAS ADJACENT TO STRUCTURES SHALL BE ACCOMPLISHED BY HAND OPERATED VIBRATORY EQUIPMENT OR MECHANICAL TAMPERS APPROVED BY THE ENGINEER. AS A MINIMUM, COMPACTION OF SELECT COMMON FILL SHALL CONSIST OF FOUR COVERAGES OF THE APPROVED EQUIPMENT.
- 7. SITE PREPARATION SHALL INCLUDE CLEARING, GRUBBING, DELETERIOUS SOILS, VEGETATION AND DEBRIS. ALL TREES, STUMPS, BRUSH, SHRUBS, ROOTS, GRASS, WEEDS, RUBBISH, STONES LARGER THAN 2-IN. IN THE LARGEST DIAMETER AND OTHER OBJECTIONABLE MATERIAL SHALL BE REMOVED AND DISPOSED OF FROM AREAS TO BE FILLED AND COMPACTED. AREAS OUTSIDE OF THE LIMITS OF WORK SHALL BE PROTECTED FROM DAMAGE AND NO EQUIPMENT OR MATERIALS SHALL BE STORED IN THESE AREAS. NO STUMPS, TREES, LIMBS, OR BRUSH SHALL BE BURIED IN ANY FILLS OR EMBANKMENTS.
- 8. EROSION AND SEDIMENT CONTROL, BOTH DURING AND AFTER CONSTRUCTION, SHALL BE PROVIDED AS REQUIRED TO RETAIN SEDIMENT ONSITE, AND TO CONTROL EROSION OF EMBANKMENTS, TEMPORARY AND FINAL EXPOSED SLOPES, AND TEMPORARY MATERIAL STOCKPILE(S). SILT FENCES, CHECK DAMS, DRAINAGE DITCHES OR SWALES, TEMPORARY SEEDING, AND PRE-MANUFACTURED TEXTILES, GEOTUBES, GEOGRID, CELLULAR GEOWEB, ETC., SHALL BE UTILIZED AS APPROPRIATE. EROSION AND SETTLEMENT CONTROL MEASURES SHALL BE IN ACCORDANCE WITH ALL PERMITS AND CODES AND THIS SPECIFICATION. DURING THE EXCAVATION OF THE WORK AT THE SITE, OPERATIONS SHALL BE CONTINUOUSLY MONITORED TO AVOID THE CREATION OF CONDITIONS THAT COULD LEAD TO EXCESSIVE EROSION OF SOIL WITH SURFACE RUNOFF FROM THE WORK AREAS. CONTROLS SHALL BE PROVIDED TO PROTECT THE WATER QUALITY AND SHALL BE IN ACCORDANCE WITH PROJECT DOCUMENTS AND ALL LOCAL, STATE AND FEDERAL LAWS AND REGULATIONS. EROSION CONTROL MEASURES SHALL BE EMPLOYED TO REDUCE EROSION OF SLOPES AND SILTATION OF OFF-SITE OUTFALLS AND TRIBUTARIES.
- 9. UPON SIGNS OF CONCENTRATED FLOW BY EVIDENCE OF GULLYING OR RILLING IN DISTURBED AREAS, FILTERMITT, OR APPROVED EQUAL, SHALL BE PLACED IN THESE AREAS, SPACED EVERY 50' IN THE UPGRADIENT SLOPE.
- 10. ALL MATERIALS (I.E. STONE, SOLAR EQUIPMENT) WILL BE OFFLOADED AND STORED WITHIN THE PROPOSED ARRAY FIELD AND DESIGNATED LAYDOWN AREA.
- 11. ALL DISTURBED AREAS (EXCLUDING 2.5:1 SLOPED AREAS) SHALL BE RE-ESTABLISHED WITH "SOLAR FARM SEED MIX", OR APPROVED EQUAL (SEE NOTES DEPICTED ON THIS SHEET).

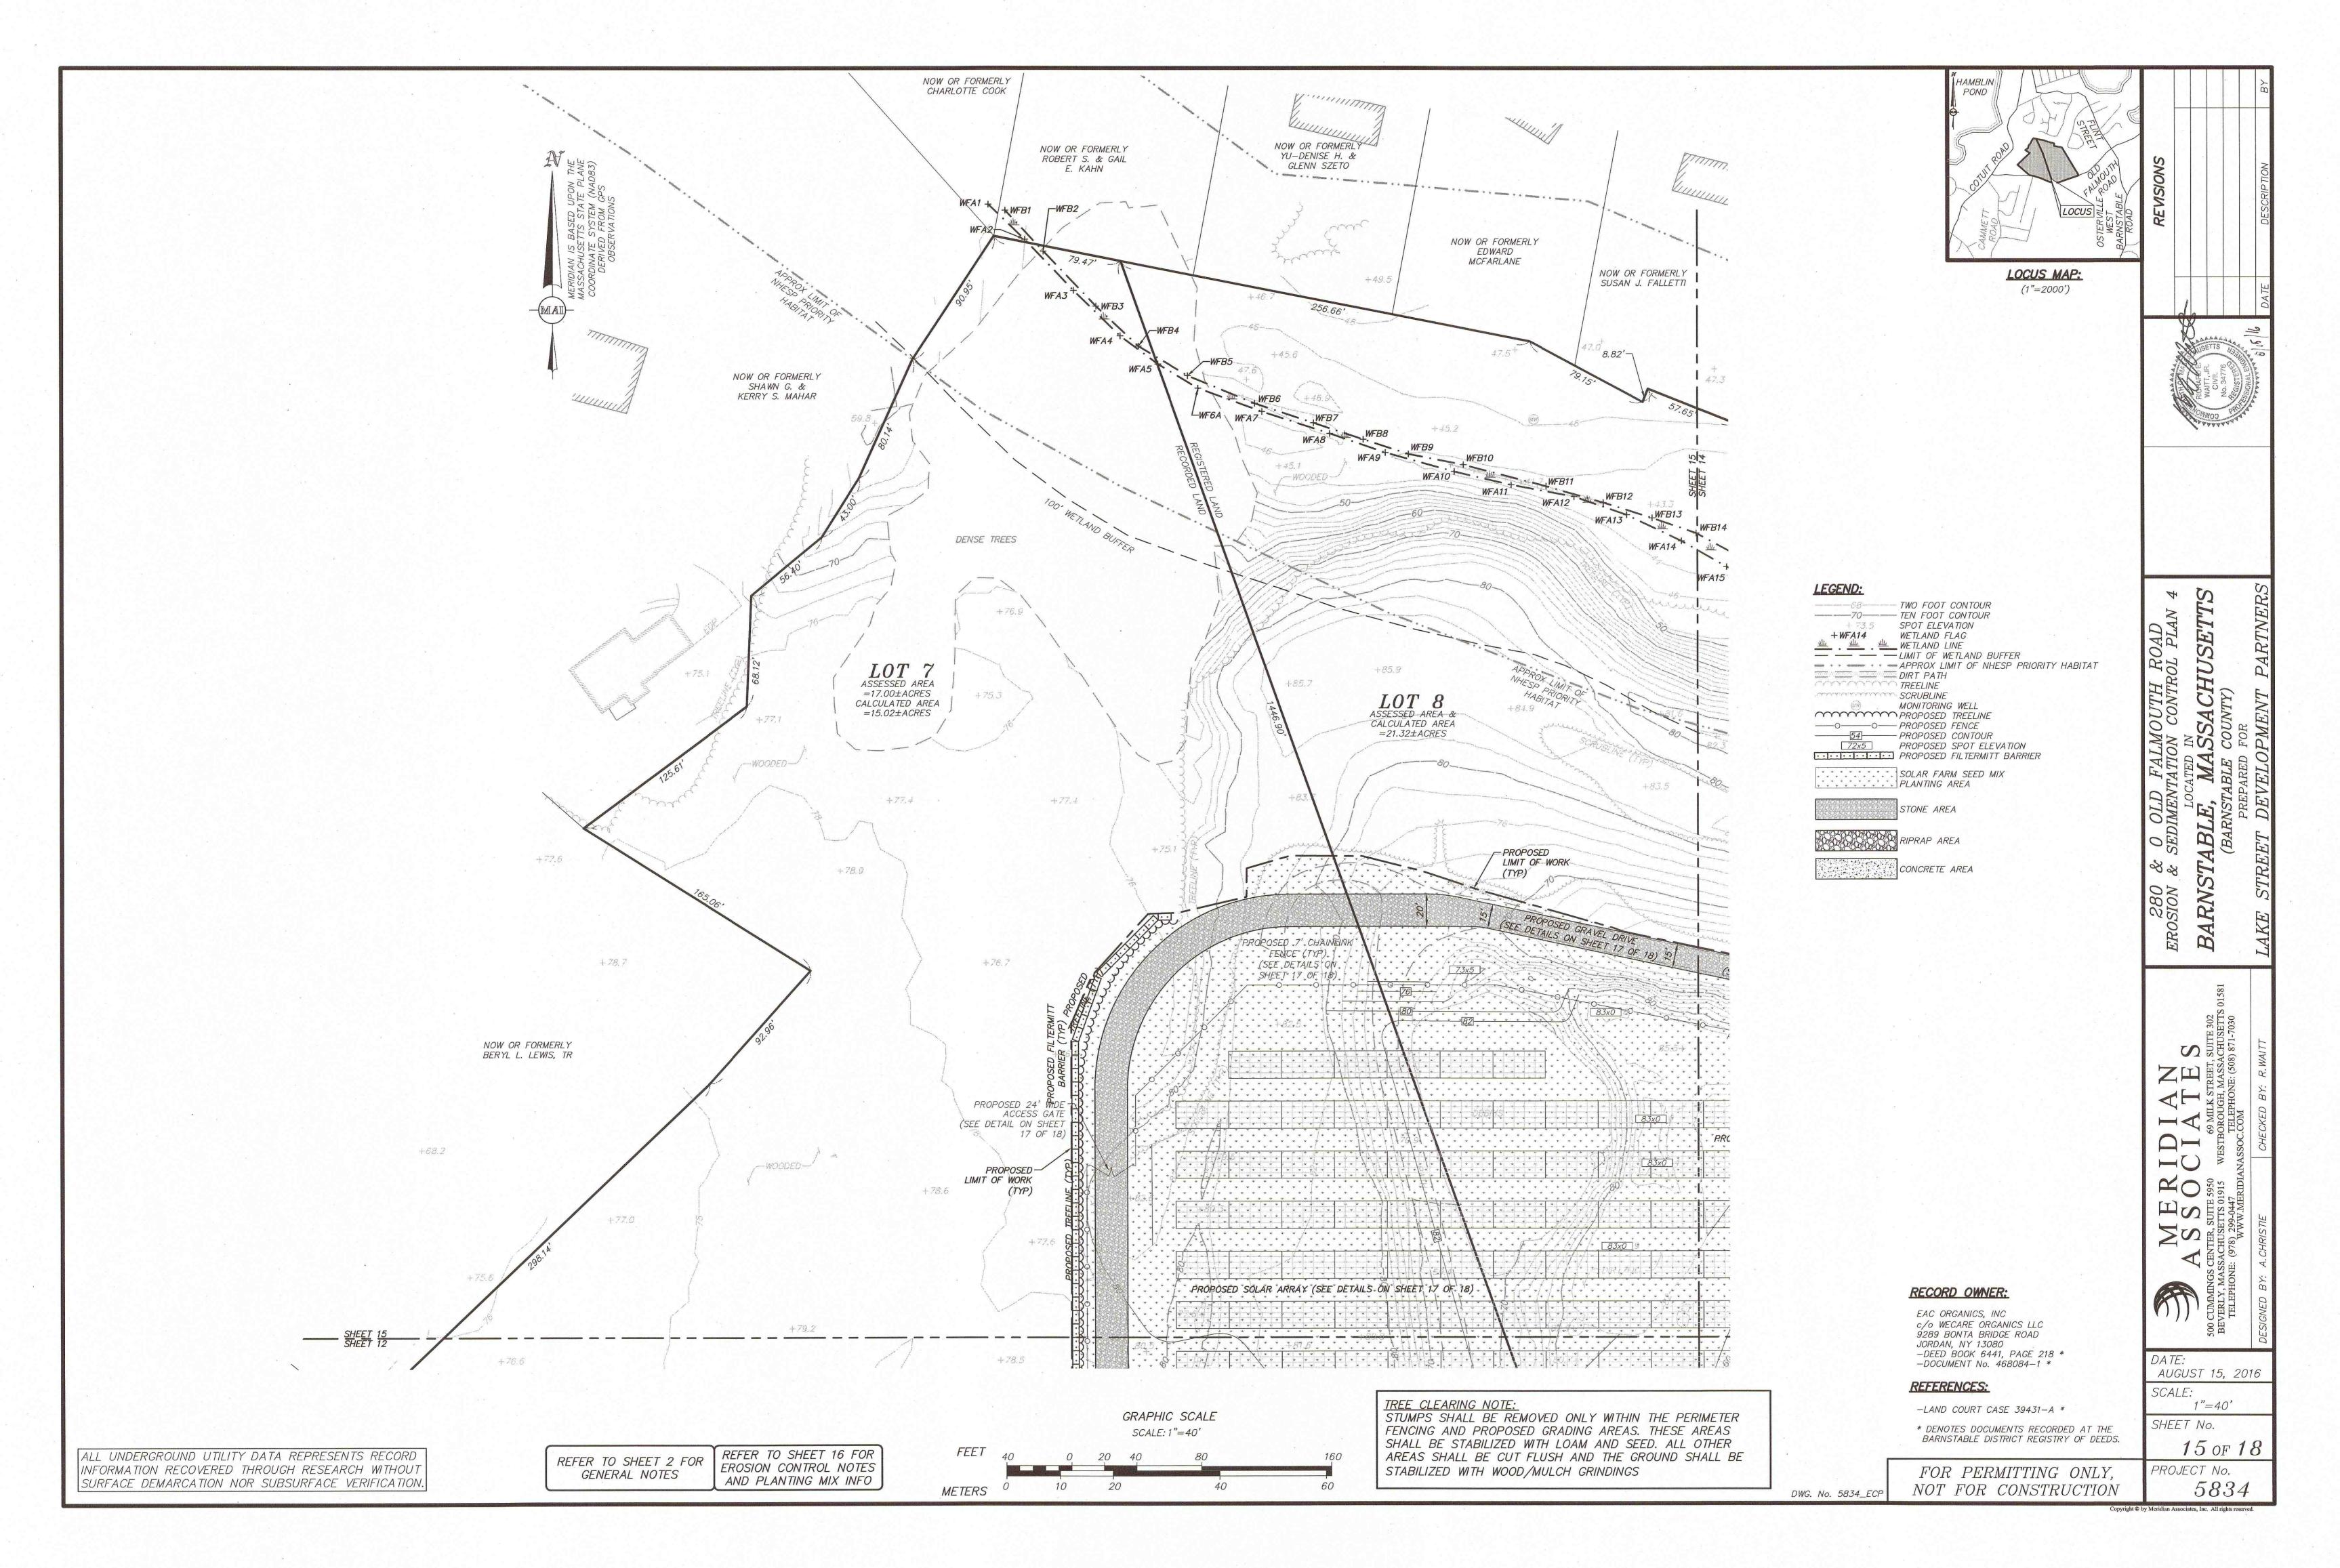

ESTABLISHED GUIDELINES FOR ERNST "SOLAR FARM SEED MIX" (© ERNST CONSERVATION SEEDS)

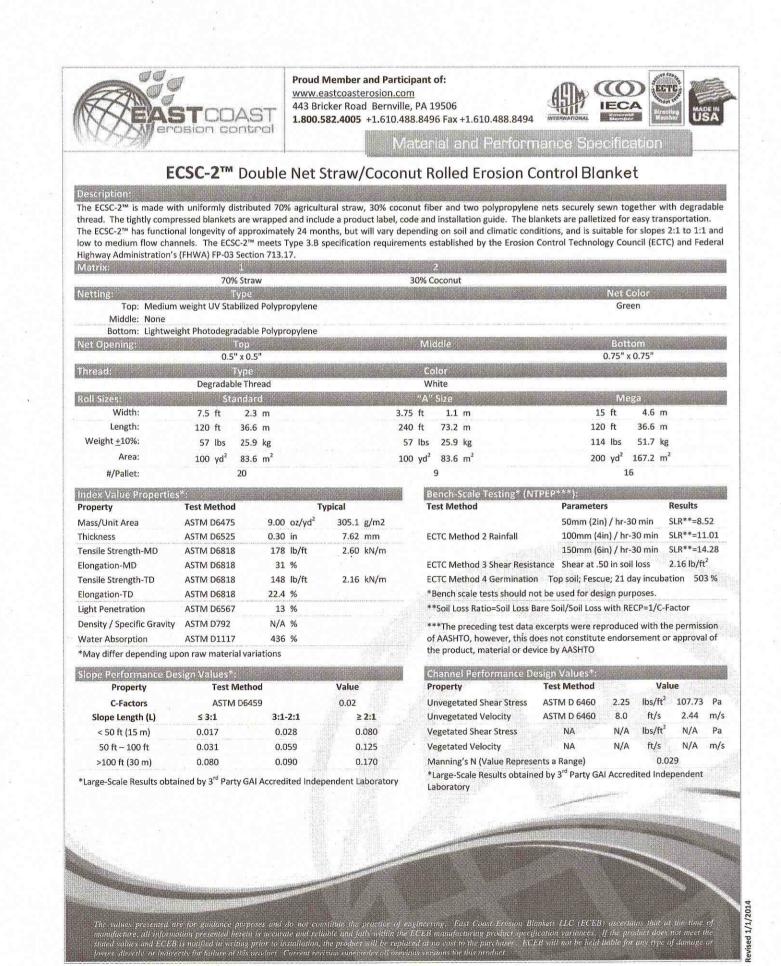GENERAL: ERNST "SOLAR FARM SEED MIX" (#186) IS A SLOW GROWING SEED MIXTURE DESIGNED FOR, BUT LIMITED TO, USE IN SOLAR ARRAY LAYOUT APPLICATIONS.

SPECIES LIST: 30% CREEPING RED FESCUE (FESTUCA RUBRA)

30% SHEEP FESCUE, 'WHISPER' (FESTUCA OVINA, 'WHISPER')

• 15% HARD FESCUE, 'HERON' (FESTUCA OVINA VAR. DURIUSCULA (F. LONGIFOLIA), 'HERON') 10% ANNUAL RYEGRASS (LOLIUM MULTIFLORUM (L. PERENNE VAR. ITALICUM))

 7.5% HARD FESCUE, 'CHARIOT' (FESTUCA BREVIPILA, 'CHARIOT') 7.5% HARD FESCUE, 'BEACON' (FESTUCA BREVIPILA, 'BEACON')

SEED BED PREPARATION:

REMOVE ALL INVASIVE SPECIES, TILL EXISTING SOIL AND RAKE SMOOTH.

SEED APPLICATION AND RATE:

THE IDEAL PLANTING DEPTH IS 1/4-1/2". UNDER IDEAL CONDITIONS SEEDS LAYING ON THE SURFACE WILL GERMINATE. RECOMMENDED APPLICATION RATE FOR SEEDING IS 6 LBS PER 1,000 SQUARE FEET. AFTER SEEDING, RAKE SEED INTO THE SOIL AND ROLL SOIL TO ENSURE GOOD SEED TO SOIL CONTACT, BUT DO NOT CRUSH SOIL AGGREGATES OR OVERLY COMPACT SOIL. IF THERE IS LACK OF NATURAL RAINFALL AT THE TIME OF SEEDING THE SEED BED SHOULD BE IRRIGATED LIGHTLY FOR A PERIOD OF 7-10 DAYS TO PROMOTE GERMINATION.

FOR FALL INSTALLATION, SEED BETWEEN AUGUST 15 AND SEPTEMBER 10. FOR SPRING INSTALLATION, SEED AS EARLY AS POSSIBLE SOMETIME BETWEEN APRIL 15 AND MAY 10.

FERTILIZATION AND SOIL REQUIREMENTS:

THE USE OF FERTILIZER WHEN ESTABLISHING NATIVE PLANT SPECIES IS NOT RECOMMENDED. THE USE OF FERTILIZERS CAN PROMOTE THE GROWTH OF WEED SPECIES AND CAN LEAD TO CONTAMINATION OF NEARBY WETLAND AREAS. IT IS RECOMMENDED TO ADD ORGANIC MATERIAL TO ALL DISTURBED AREAS AFTER THE TOPSOIL HAS BEEN REMOVED OR DEPLETED, THIS WILL IMPROVE SOIL FERTILITY.

GRASSY WEEDS OR PERSISTENT PERENNIALS CAN RE-ESTABLISH IN THESE SOIL TYPES. WEED CONTROL IS CRITICAL IN THE FIRST AND SECOND YEARS AFTER PLANTING. APPLICATIONS OF SPECIFIC HERBICIDES PROVIDED BY LOCAL VENDORS CAN HELP CONTROL GRASSY AND PERSISTENT WEED SPECIES, SUCH AS DANDELIONS, THISTLE, ETC.

ESTABLISHMENT:

USUALLY, A NATIVE ESTABLISHMENT TAKES 2-3 YEARS TO BECOME FULLY RECOGNIZABLE. DURING THIS PERIOD, VIGILANT WEED CONTROL (MOWING HIGH AND/OR AN HERBICIDE APPLICATION) IS NECESSARY TO ASSIST IN ESTABLISHMENT. RE—SEEDING MAY BE REQUIRED UNTIL THE SEED MIX CAN ESTABLISH ITSELF. IRRIGATION MAY BE NECESSARY IF PRECIPITATION IS INFREQUENT, CONDITIONS ARE HOT WITH HIGH SUNLIGHT INTENSITY, AND/OR SOILS DO NOT HOLD WATER (I.E., SANDY SOILS).

WASS DOT SEED MIX FOR SLOPES AND SHOULDERS

(M6.03.0 SEED)

THE GRASS SEED SHALL CONFORM TO THE REQUIREMENTS OF THE FOLLOWING TABLE:

FOR SLOPES AND SHOULDERS.

- 50% CREEPING RED FESCUE 30% KENTUCKY 31
- 10% DOMESTIC RYE • 5% RED TOP

• 5% LADINO CLOVER

THE SEED SHALL BE FURNISHED AND DELIVERED PREMIXED IN THE PROPORTIONS SPECIFIED ABOVE. ALL SEED SHALL COMPLY WITH STATE AND FEDERAL SEED

THE SEED MIXTURE SPECIFIED FOR SLOPES AND SHOULDERS CONSISTS OF A TOUGH HARDY TYPE FOR USE ON SLOPES GRADED AT THE RATE OF 4:1, AND STEEPER SLOPES OR AS OTHERWISE DIRECTED.

> 4" LOAM AND SEED. AS NEEDED. IN AREAS OF UNSUITABLE TOPSOIL


UNDISTURBED OR COMPACTED SUBGRADE - REMOVE ALL TOPSOIL AND

(NOT TO SCALE)


LOAM & SEED

UNSUITABLE MATERIAL

SECTION END VIEW

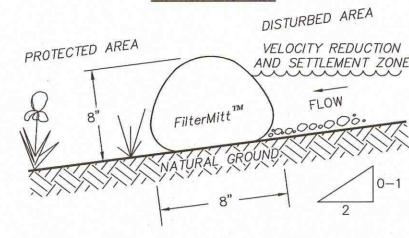

UNION END VIEW

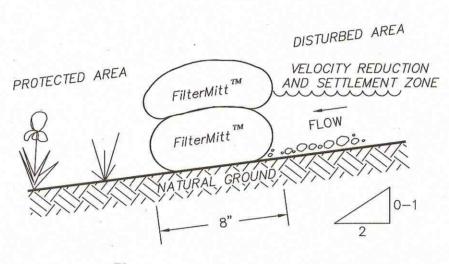

FilterMitt " COMPONENTS

(AVE. 11.5 LBS./L.F.)

OUTSIDE CASING: 100% organic hessian. FiberRoot Mulch M FILLER INGREDIENT:

• A BLEND OF COARSE AND FINE COMPOST AND SHREDDED • PARTICLE SIZES: 100% PASSING A 3" SCREEN; 90-100% PASSING A 1" SCREEN; 70-100% PASSING A 0.75"

SCREEN; 30-75% PASSING A 0.25" SCREEN. • WEIGHT: APPROX. 310 LBS./CU.YD.


> For more information visit: www.groundscapesexpress.com_or

contact us at: Groundscapes Express, Inc.

P.O. Box 737 Wrentham, MA 02093 (508) 384-7140

FILTERMITT. OR APPROVED EQUAL (2:1 SLOPES OR LESS)

(NOT TO SCALE)

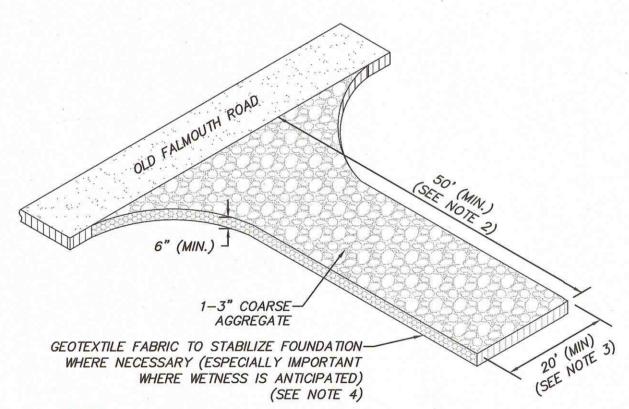

NOTES:

- 1. THE SOLE PURPOSE OF THIS DETAIL IS TO PROVIDE A STABLE ENTRANCE AND EXIT FROM A CONSTRUCTION SITE AND KEEP MUD AND SEDIMENT OFF PUBLIC ROADS IN ACCORDANCE WITH THE RECOMMENDATIONS STATED IN THE "MASSACHUSETTS EROSION AND SEDIMENT CONTROL GUIDELINES FOR URBAN AND SUBURBAN AREAS" AS PREPARED BY THE MASSACHUSETTS DEPARTMENT OF ENVIRONMENTAL PROTECTION.
- 2. EXTEND PAD BEYOND 50 FEET FOR HEAVY CONSTRUCTION TRAFFIC AS NECESSARY. LONGER ENTRANCES WILL PROVIDE BETTER CLEANING ACTION.
- 3. THE PAD SHALL EXTEND THE FULL WIDTH OF THE CONSTRUCTION ACCESS DRIVE OR 20 FEET WHICH EVER IS GREATER.
- 4. WHERE NECESSARY, GEOTEXTILE FILTER FABRIC SHALL BE PLACED BETWEEN THE STONE FILL AND THE EARTH SURFACE BELOW THE PAD TO REDUCE THE MIGRATION OF SOIL PARTICLES FOR UNDERLYING SOIL INTO THE STONE AND VICE VERSA.

TEMPORARY GRAVEL CONSTRUCTION ENTRANCE/EXIT PAD

(NOT TO SCALE)

GENERAL SEQUENCE OF CONSTRUCTION:

SECTION TOP VIEW

UNION TOP VIEW

PROTECTED

AREA

PROTECTED

WITH THE NEWEST TECHNOLOGY AND EQUIPMENT,

THE FLEXIBILITY OF FilterMitt M ALLOWS IT TO

CONFORM TO ANY CONTOUR OR TERRAIN WHILE

SECTIONS CAN BE CONSTRUCTED ON SITE IN LENGTHS

SECTIONS CAN ALSO BE DELIVERED TO THE SITE IN

HOLDING A SLIGHTLY ROUND SHAPE AT 8" HIGH BY

WHERE SECTION ENDS MEET, THERE SHALL BE AN

FilterMitt "INSTALLATION:

LENGTHS FROM 1' TO 8'.

OVERLAP OF 6" OR GREATER.

FROM 1' TO 100'.

8" WIDE.

FLOW

DISTURBED

AREA

00

OVERLAP

DISTURBED

- 1. CONTACT DIGSAFE (888.344.7233) AND OBTAIN CLEARANCE AT LEAST 72 HOURS BEFORE INITIATING ANY EXCAVATION.
- 2. ESTABLISH EROSION AND SEDIMENTATION CONTROL MEASURES (FILTERMITT) AS DEPICTED HEREIN AND AROUND AREAS OF DISTURBANCE AND MAINTAIN THROUGHOUT CONSTRUCTION IN ACCORDANCE WITH LOCAL REQUIREMENTS. PERFORM INSPECTIONS, REPAIR IF NECESSARY, AND DOCUMENT AFTER EACH PRECIPITATION EVENT OF 0.25-INCHES OR GREATER.
- 3. PRIOR TO CONSTRUCTION, THE CONTRACTOR SHALL CONSTRUCT THE TEMPORARY GRAVEL CONSTRUCTION ENTRANCE/EXIT PAD AT OLD FALMOUTH ROAD. THE PAD SHALL CONSIST OF 1.5"-2" COARSE AGGREGATE WITH MINIMUM DIMENSIONS OF 50' (LENGTH) x 20' (WIDTH) x 6" (DEPTH) AND SET ON GEOTEXTILE FABRIC TO STABILIZE FOUNDATION (ESPECIALLY IMPORTANT WHERE WETNESS IS ANTICIPATED).
- 4. SITE PREPARATION SHALL INCLUDE CLEARING AND REMOVAL OF EXISTING VEGETATION AND DEBRIS. ALL TREES. STUMPS, BRUSH, SHRUBS, ROOTS, GRASS, WEEDS, RUBBISH, BITUMINOUS PAVEMENT, STONES LARGER THAN 2-IN. IN THE LARGEST DIAMETER AND OTHER OBJECTIONABLE MATERIAL SHALL BE REMOVED AND DISPOSED OF FROM AREAS TO BE FILLED AND COMPACTED. AREAS OUTSIDE OF THE LIMITS OF WORK SHALL BE PROTECTED FROM DAMAGE AND NO EQUIPMENT OR MATERIALS SHALL BE STORED IN THESE AREAS. NO STUMPS, TREES, LIMBS, OR BRUSH SHALL BE BURIED IN ANY FILLS OR EMBANKMENTS.
- 5. DEMOLISH THE EXISTING STRUCTURES, CONCRETE SLAB FOUNDATIONS, STEPS, FREE-STANDING WALLS, AND RETAINING WALLS. ELECTRIC, WATER, AND IRRIGATION LINES TO BE REMOVED. SEPTIC SYSTEM AND LEECHING PIT TO BE PUMPED AND THEN ABANDONED IN PLACE PER TITLE 5 REQUIREMENTS. ABANDONMENT TO BE COORDINATED WITH THE BARNSTABLE BOARD OF HEALTH.
- 6. CONSTRUCT TEMPORARY SEDIMENTATION BASINS AND RIPRAP LEVEL SPREADERS (SHOWN ON
- 7. GRADE THE SITE IN ACCORDANCE WITH THE SITE PLANS.
- 8. GRUBBING OF AREAS WITHIN THE ARRAY FOOTPRINT SHALL BE CONDUCTED AFTER THE INSTALLATION OF THE SEDIMENTATION BASINS AND RIPRAP LEVEL SPREADERS.
- 9. CONSTRUCT GRAVEL ACCESS ROAD AND TEMPORARY CONSTRUCTION PARKING AREA AS DEPICTED ON THE SITE PLAN.
- 10. FOR AREAS WHERE NO GRADING IS PROPOSED, REPAIR UNEVEN AREAS WITHIN LIMITS OF THE SOLAR DEVELOPMENT, AS NECESSARY TO CREATE A UNIFORM GROUND SURFACE. GENERAL TOLERANCE FOR ALLOWABLE GROUND SLOPE IS TWO FOOT VERTICAL CHANGE OVER A 20 FOOT HORIZONTAL RUN [NOTE THAT THIS REFERS TO THE ALLOWABLE LONGITUDINAL SLOPE (I.E., ALONG THE CONTOUR) AND NOT THE INCLINATION OF THE EXPOSURE (I.E., PERPENDICULAR TO THE CONTOUR)].
- 11. UPON SIGNS OF CONCENTRATED FLOW BY EVIDENCE OF GULLYING OR RILLING IN DISTURBED AREAS, FILTERMITT, OR APPROVED EQUAL, SHALL BE PLACED IN THESE AREAS, SPACED EVERY 50' IN THE UPGRADIENT SLOPE.
- 12. ESTABLISH THE TEMPORARY LAYDOWN AREA FOR CONSTRUCTION SUPPORT AND MATERIAL STAGING AS DEPICTED HEREIN PRIOR TO THE DELIVERY OF MODULAR UNITS.
- 13. RECEIVE AND STAGE MATERIALS. RE-LOCATE COMPONENTS (E.G., CONDUIT, WIRING AND POSTS) TO SOLAR DEVELOPMENT AREA AS THEY ARE REQUIRED.
- 14. INSTALL RACKING SYSTEM, MOUNT THE PV PANELS ON FRAME AT THE SPECIFIED ORIENTATION AND EXPOSURE (TO BE PROVIDED BY PROJECT MEP PRIOR TO CONSTRUCTION).
- 15. RUN UNDERGROUND ELECTRICAL CONDUIT TO PV FRAMES AND INSTALL PANEL WIRING. (LOCATION TO BE PROVIDED BY PROJECT MEP PRIOR TO CONSTRUCTION)
- 16. INSTALL PV COMBINER BOXES WITH FLEXIBLE CONNECTIONS TO CONNECT PV PANELS TO CONDUIT. (LOCATION TO BE PROVIDED BY PROJECT MEP PRIOR TO CONSTRUCTION)
- 17. CONSTRUCT CONCRETE EQUIPMENT PAD. INSTALL AND CONNECT GROUND MOUNTED ELECTRICAL EQUIPMENT. A DISCONNECT LOCATION WILL BE ON THE OUTSIDE ON THE NARROWEST SIDE OF THE
- 18. RUN CONDUIT FROM THE CONCRETE EQUIPMENT PAD TOWARDS THE POINT OF INTERCONNECTION
- AS DEPICTED ON THE SITE PLAN. 19. INSTALL RISER POLES AND UTILITY POLES WITH ELECTRICAL COMPONENTS AND OVERHEAD WIRING
- AT POINT OF INTERCONNECTION. 20. CONSTRUCT ALL 7' HIGH CHAIN LINK FENCE AND GATES (SHOWN ON PLAN) WITH KNOX BOXES AT EACH LOCATION DEPICTED ON THE SITE PLANS.
- 21. ALL DISTURBED AREAS SHALL BE RE-ESTABLISHED WITH "SOLAR FARM SEED MIX" AND MA DOT SEED MIX FOR SHOULDER AND SLOPES (AS DEPICTED ON THE EROSION AND SEDIMENTATION CONTROL PLANS AND HEREIN). IN THE EVENT THAT THE SEEDING FALLS OUTSIDE OF THE RECOMMENDED SEEDING DATÉS, DISTURBED AREAS SHALL BE RE-ESTABLISHED USING
- 22. REMOVE ANY ACCUMULATED SEDIMENT FROM THE TEMPORARY SEDIMENTATION BASINS AND RIPRAP LEVEL SPREADERS.

ALTERNATIVES METHODS AS APPROVED BY THE PROJECT SITE ENGINEER.

23. CONSTRUCT INFILTRATION BASINS (AS DEPICTED ON THE SITE PLANS).

DWG. No. 5834_ECP

24. UPON COMPLETION OF CONSTRUCTION ACTIVITIES WITHIN THE LIMIT OF WORK, THE CONTRACTOR SHALL EFFECTIVELY AND PERMANENTLY STABILIZE THE SITE.


AUGUST 15, 2016


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16 of 18 PROJECT No.

NOT FOR CONSTRUCTION

FOR PERMITTING ONLY




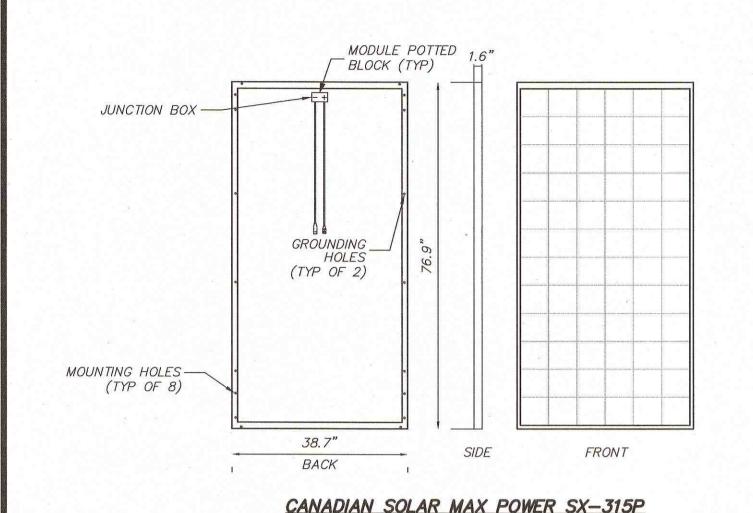


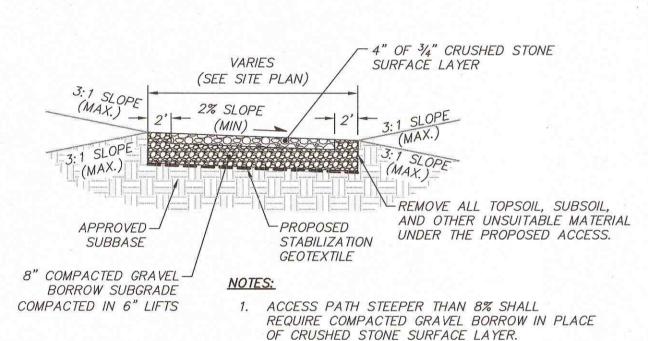MODULE. OR APPROVED EQUAL


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TYPICAL GRAVEL ACCESS DRIVE CROSS SECTION (NOT TO SCALE)




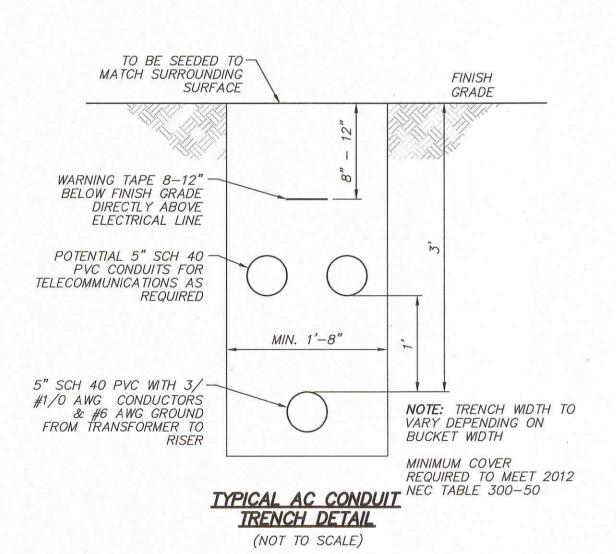


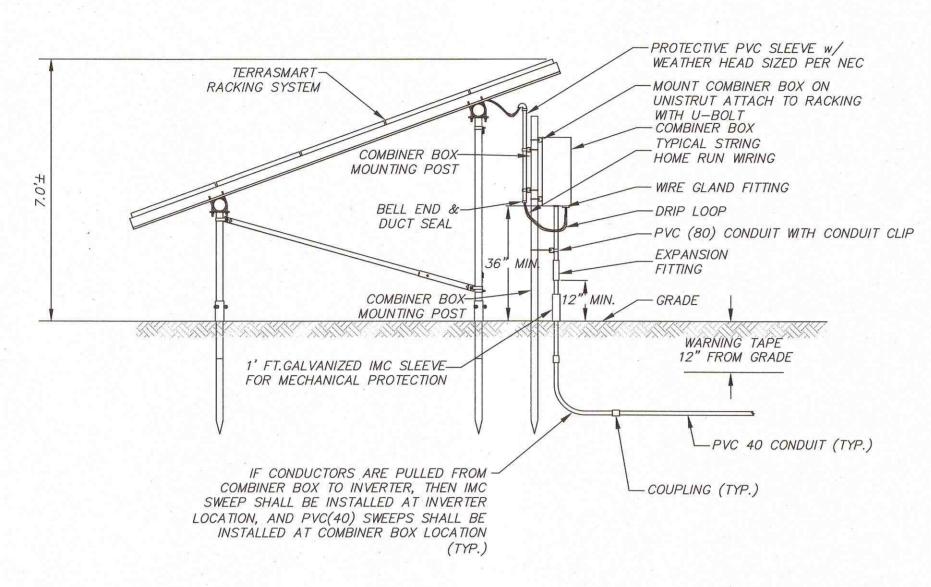TYPICAL RACK SECTION WITH COMBINER. OR APPROVED EQUAL (NOT TO SCALE)

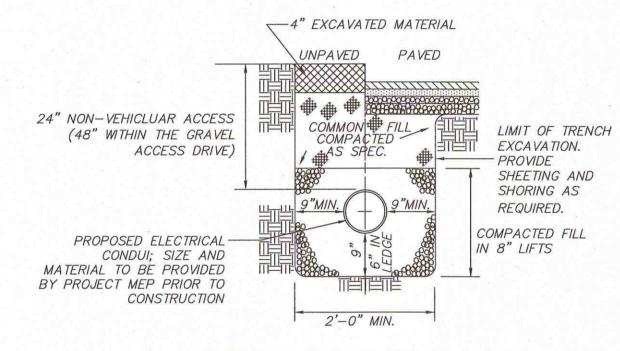

TYPICAL CONDUIT TRENCH DETAIL (NOT TO SCALE)

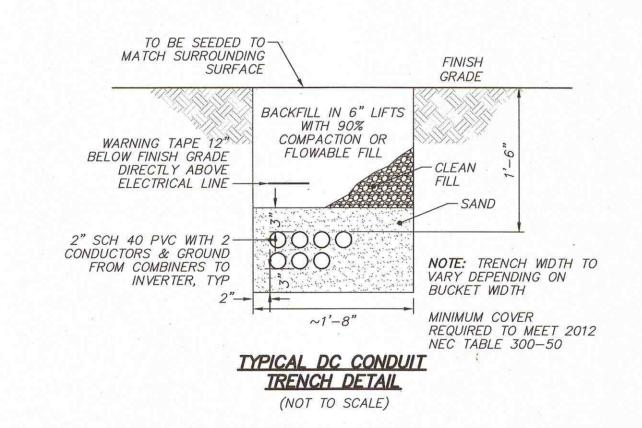

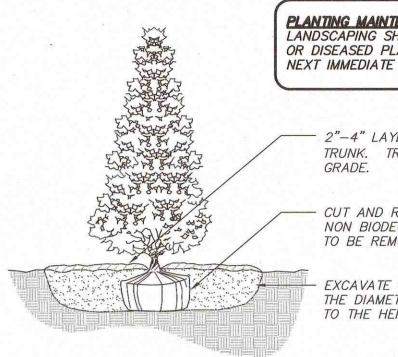

PLANTING MAINTENANCE NOTES: LANDSCAPING SHALL BE PROPERLY MAINTAINED, ANY DEAD OR DISEASED PLANTINGS SHALL BE REPLACED IN THE NEXT IMMEDIATE SPRING OR FALL PLANTING SEASON.

> 2"-4" LAYER OF MULCH. KEEP MULCH 2" BACK FROM TRUNK. TRUNK FLARE TO REMAIN 1"-2" ABOVE FINISH


- CUT AND REMOVE AS MUCH BURLAP AS POSSIBLE, IF NON BIODEGRADABLE REMOVE ENTIRELY. WIRE BASKETS TO BE REMOVED ENTIRELY.


EXCAVATE PLANTING HOLE TO A WIDTH THREE TIMES THE DIAMETER OF THE ROOTBALL AND A DEPTH EQUAL TO THE HEIGHT.

NOTES:

- 1. BACKFILL PLANTING HOLE WITH EXISTING SOIL AMENDED AS NECESSARY.
- 2. BACKFILL HALF THE SOIL AND WATER TO SETTLE OUT AIR POCKETS, COMPLETE BACKFILLING AND REPEAT WATERING.
- 3. IF ROOTS ARE CIRCLING THE ROOTBALL EXTERIOR, CUT ROOTS VERTICALLY IN SEVERAL PLACES PRIOR TO PLANTING.
- 4. PLANTING HEIGHT SHALL BE MAINTAINED AT A MAXIMUM HEIGHT OF 8' TO AVOID POTENTIAL SHADING IMPACT ON ARRAY.

TREE PLANTING (NOT TO SCALE)

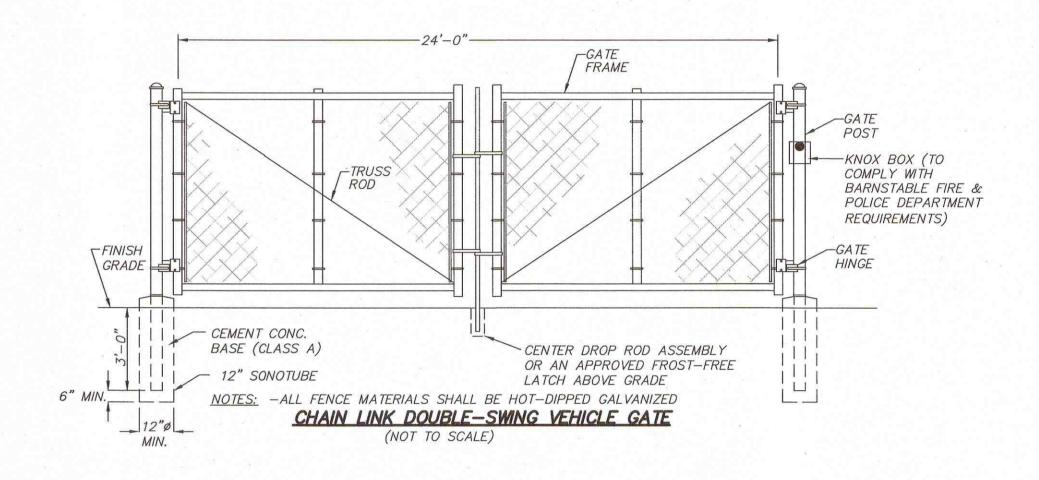

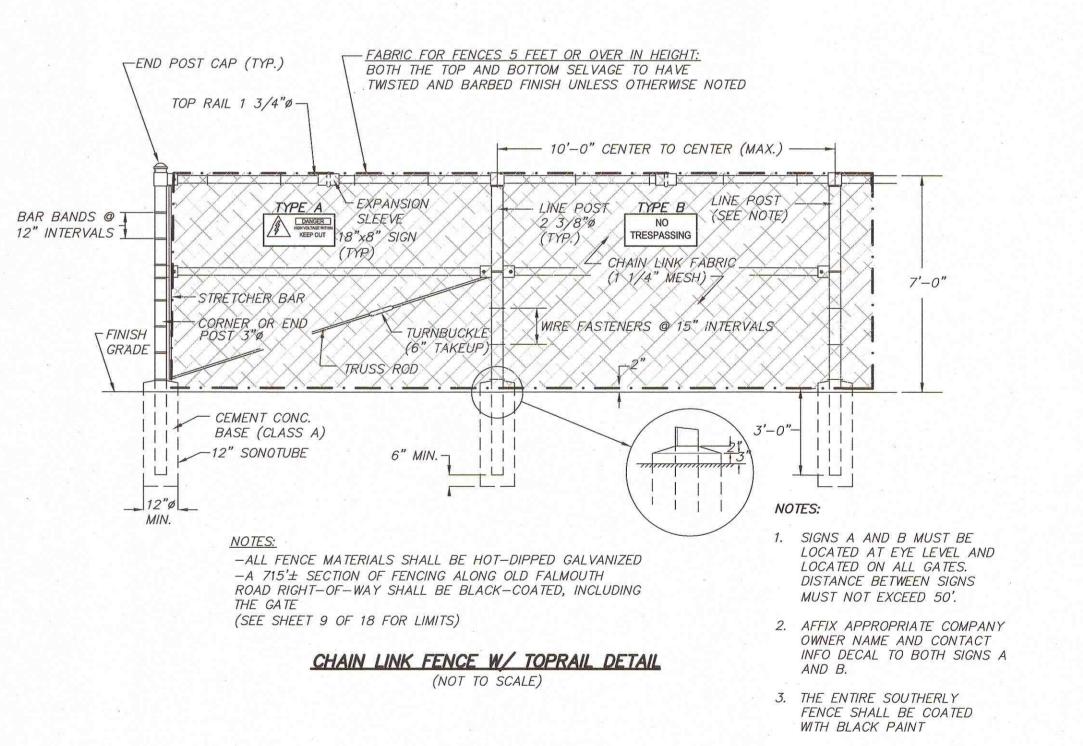

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DWG. No. 5834_DE7



O OLD IRNSTABLE, (BARNS)

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AUGUST 15, 2016 SCALE: AS NOTED

> SHEET No. 17 of 18

PROJECT No. 5834

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